18-PC-09-33 CITY OF HAPEVILLE

CITY OF HAPEVILLE ECONOMIC DEVELOPMENT DEPARTMENT PLANNING COMMISSION APPLICATION

A STATE OF THE PROPERTY OF THE
Name of Applicant
Mailing Address: 2617 they 42 Looust Grove Go. 30248
Telephone Mobile # Email
Property Owner (s) William Carcia
Mailing Address 3515 IN pustrial Bird Haperil-6a. 30354
Telephone Mobile #
Address/Location of Property: 750c. Hy Street Link St. Hapen 166a. 30354
Parcel I.D. # (INFORMATION MUST BE PROVIDED):
Present Zoning Classification: Yes Javila Size of Tract: 0.17 1/2 acre(s)
Present Land Use: residential
Please check the following as it applies to this application
Site Plan Review
Conditional Use Permit Other (Please State)
hereby make application to the City of Hapeville, Georgia for the above referenced property. I do hereby swear or affirm that the information provided here and above is true, complete and accurate, and I understand that any inaccuracies may be considered just cause for invalidation of this application and any action taken on this application. I understand that the City of Hapeville, Georgia, reserves the right to enforce any and all ordinances. I further understand that it is my/our responsibility to conform with all of City of Hapeville's Ordinances in full. I hereby acknowledge that all requirements of the City of Hapeville shall be adhered too. I can read and write the English language and/or this document has been read and explained o me and I have full and voluntarily completed this application. I understand that it is a felony to make false statements or writings to the City of Hapeville, Georgia pursuant to C.C.G.A. 16 10-20 and I may be prosecuted or a violation thereof. Applicant's signature Date: 13 - 8
Sworn to and subscribed before me This 13th day of Aug., 2018. Occause a Rayle Notary Public This 13th day of Aug., 2018. Occause a Rayle Notary Public

CITY OF HAPEVILLE ECONOMIC DEVELOPMENT DEPARTMENT PLANNING COMMISSION APPLICATION

AUTHORIZATION OF PROPERTY OWNER

I CERTIFY THAT I AM THE OWNER OF THE PROPERTY LOCATED AT:	
105 750 LILLY STreet	
105 750 LILLY STreet Haper/119 Ga. 30354	
City of Hapeville, County of Fulton, State of Georgia	
WHICH IS THE SUBJECT MATTER OF THIS APPLICATION. I AUTHORIZE THE APBELOW TO ACT AS THE APPLICANT IN THE PURSUIT OF THIS APPLICATION COMMISSION REVIEW.	PLICANT NAMED FOR PLANNING
Name of Applicant Jimmy & Joyner	_
Name of Applicant Jimmy L Joyner Address of Applicant 2617 Hung 42 Locus + 6	rovE 69.30248
Telephone of Applicant	
Signo	ature of Owner
Willian	
Personally Speared Before the this 13 day of 20908T 20	18
Notary Public VIII	
S COTARL &	
PUBLIC OF	5

CITY OF HAPEVILLE ECONOMIC DEVELOPMENT DEPARTMENT PLANNING COMMISSION APPLICATION

WRITTEN SUMMARY

In detail, provide a summary of the proposed project in the space provided below. (Please type or print legibly.)	
New RosiDentier Alma Cowstruct	FION

Site Plan Checklist - Please include with your application.

A site plan is used to determine the practical ability to develop a particular property within the City of Hapeville. Information relating to environmental condition, zoning, development impact, consistency with the Hapeville Comprehensive Plan and relevant town master plans will be considered in the decision process. To be considered, a site plan <u>must</u> contain the following information:

(Please $\underline{\textit{initial}}$ each item on the list above certifying the all required information has been included on the site plan)

V

A brief project report shall be provided to include an explanation of the character of the proposed development, verification of the applicant's ownership and/or contractual interest in the subject site, and the anticipated development schedule. Please complete and submit all forms contained within the application for site plan review.



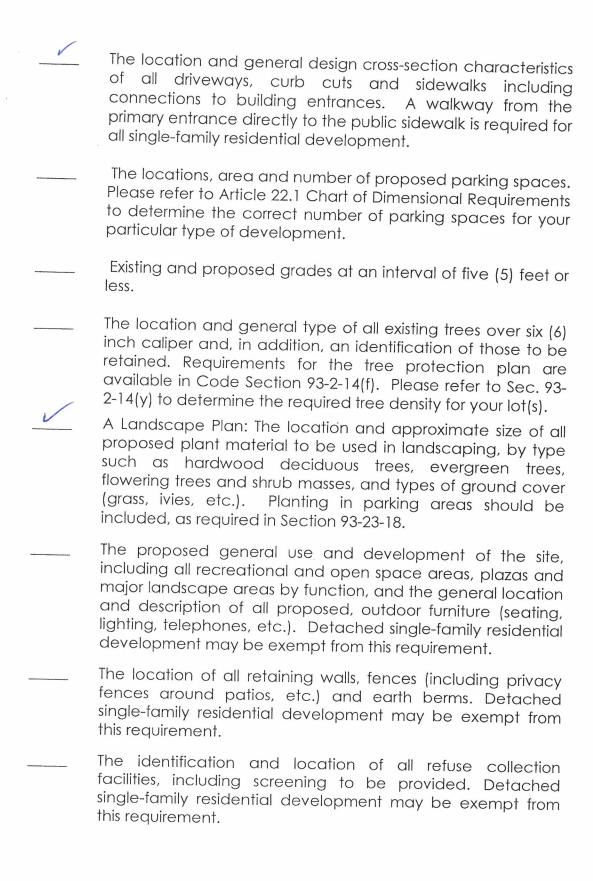
Site plans shall be submitted indicating project name, applicant's name, adjoining streets, scale, north arrow and date drawn.



The locations, size (sf) and height (ft) of all existing and proposed structures on the site. Height should be assessed from the base of the foundation at grade to the peak of the tallest roofline.



Site plans shall include the footprint/outline of existing structures on adjoining properties. For detached single-family residential infill development, the front yard setback shall be assessed based on the average setback of existing structures on adjoining lots. Where practical, new construction shall not deviate more than ten (10) feet from the average front yard setback of the primary residential structure on an adjoining lot. Exemption from this requirement due to unnecessary hardship or great practical difficulty can be approved at the discretion of the Planning Commission. To be considered for an exemption, the applicant must submit a "Request for Relief" in writing with their site plan application, including the conditions that necessitate relief (i.e. floodplain, wetland encroachment, excessive slope, unusual lot configuration, legally nonconforming lot size, unconventional sitting of adjoining structures, etc).



Location and size of all signs. Detached single-family residential development may be exempt from this requirement. Typical elevations of proposed building provided at a reasonable scale (1/8" = 1'0") and include the identification of proposed exterior building materials. Exterior elevations should show all sides of a proposed building. Site area (square feet and acres). Allocation of site area by building coverage, parking, loading and driveways, and open space areas, including total open space, recreation areas, landscaped areas and others. Total dwelling units and floor area distributed generally by dwelling unit type (one-bedroom, two-bedroom, etc.) where applicable. Floor area in nonresidential use by category. Detached single-family residential development may be exempt from this requirement. Total floor area ratio and/or residential density distribution. Number of parking spaces and area of paved surface for parking and circulation At the discretion of the planning commission, analyses by qualified technical personnel or consultants may be required as to the market and financial feasibility, traffic impact, environmental impact, storm water and erosion control, etc. of the proposed development.	***************************************	Provisions for both on-site and offsite storm-water drainage and detention related to the proposed development.
redsortable scale (1/8" = 10") and include the identification of proposed exterior building materials. Exterior elevations should show all sides of a proposed building. Site area (square feet and acres). Allocation of site area by building coverage, parking, loading and driveways, and open space areas, including total open space, recreation areas, landscaped areas and others. Total dwelling units and floor area distributed generally by dwelling unit type (one-bedroom, two-bedroom, etc.) where applicable. Floor area in nonresidential use by category. Detached single-family residential development may be exempt from this requirement. Total floor area ratio and/or residential density distribution. Number of parking spaces and area of paved surface for parking and circulation At the discretion of the planning commission, analyses by qualified technical personnel or consultants may be required as to the market and financial feasibility, traffic impact, environmental impact, storm water and erosion control etc.		residential development may be exempt from this
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		as to the market and financial feasibility, traffic impact, environmental impact, storm water and erosion control etc.

Please <u>initial</u> each item on the list above certifying the all required information has been included on the site plan, sign and submit this form with your site plan application. Failure to include this form and information required herein may result in additional delays for the consideration of your application.

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Plat Book 417 Page 124
Filed and Recorded 3/5/2019 8:57:00 AM
2019-0127181
Cathelene Robinson
Clerk of Superior Court
Fulton County, GA
Participant IDs: 0708383923

2-04-19 Date reyor No. 2557

CLERK	
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RESERVED	SUPERIOR
BLOCK	OF THE
#S B	O

Final Plat Approval

This subdivision plat has been reviewed by the Plannin and the City Engineer and found to be in compiliance or discontinuous of the City of Hop Regulations and Subdivision Regulations are amended. Deen by all other affected City and Countly Departmen appropriate. The Mayor and City Countl Inerby approvisions and requirements of the City and the provisions and the requirements of the Deal and the provisions and the requirements accused to development between the Count of the City of Hopp Commons on Maintenance Agreement accused to development between the Count of the City of Hopp City City Countly Count

PANEMENT PATCH DETAILS AND SEWER MAIN CONNECTION DETAILS SHALL B SUBMITED TO AND APPROVED BY THE COMMUNITY SERVICE DEPARTMENT RIGHT TO CONSTRUCTING THE SEWER SERVICE LINE WORK IN HOPE STREET RIGHT-OF-WAY



Owner's Ackowledgement.

THE CITY OF HAPEVILLE SASSUMES NO RESPONSBILTY FOR OVERFLOW OR BROSON OF MATURAL OR ARTHROLAL DRAMS BEYON THE EXTENT OF THE STREET RICHT-OF-WAY OR FOR THE EXTENSION OF CALLVERTS BEYOND THE POINT SHOWN ON THE APPROVED AND RECORDED PLAT AND IN HAT THE CITY OCCS. NOT ASSUME RESPONSBILLTY FOR MAINTENANCE OF PIPES AND DRAMACE DISCHARMEN BEYOND THE CITY RICHT-OF-WAY. STRUCTURES OF MENT THAN STROND DRAMAGE STRUCTURES ARE NOT PERMITTED IN DRAINAGE EAST-MENTS.

N/F DANIEL ADOLPHUS DB 9368 PG 113 ZONED R-1 NCKIE JOHNSON DB 38053 PG 204 ZONED R-1 N/F LOR PAYTON OB 50203 PG 4 ZONED R-1 (HESCOHOED) ULLY STREET FERSE STEEP STEEP STEEP STEEP 8 17.23 10 97.23 11 9 TIONE CURB APPARENT 40' R/W # 68 68 68 # 68 68 68 EXISTING II

= 27*P-N.E

= 18*P-N.F

= 24*MAGNOLIA

= 26*P-N.E 8888 THE SEWER SERVICE CONSTRUCTION SHOULD BE COMPLETED AND ACCEPTED BY THE CITY PRIOR TO ISSUANCE OF A BUILDING PERMIT

AS PER FLOOD INSURANCE RATE MAP OF FULTON COUNTY, GA. COMMINITY PAYEL NO. 13/2100251F INS POPERTY IS NOT LOCATED IN A FLOOD HAZARD ZONE. DATED 9-18-2013
REFERENCES: LOTS 3 & 4 AS RECORDED IN PB 14 PG 32 VARIANCE APPLICATION 18-PC-12-39

PROPERTY DIVISION SURVEY BURTON & ASSOCIATES SUSTAINED SURVEY STREET 1740 Hudens findge Rd 3202 BC 1226 BC 1226 STREET ST	bdaino@elisouth.net	LAND LOT 99 COUNTY FULTON DATE 11-12-18	DISTRICT 14 GTY HAPEVILLE REMSED 1-03-19	SCALE 1"==50" JOB NO. 103018GA	
PROPERTY DIVISION SURVEY E 3202 HOPE STREET PID# 1400990040421	GARVA INVESTMENT	200 75 00 AV	ă de la companya de l	GRAPHIC SCALE (IN FIGET) SC	



TWO STOREY SINGLE FAMILY

105 LILLY STREET

HAPEVILLE, GA 30354



OR INFORMATION CONTACT:

JAM GARCIA
ZIP INDUSTRIAL BLVD

VILLE, GA 30354

ENGINEER:

RENDERED VIEW

105 LILLY STREET HAPEVILLE, GA 30354

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	REVISIONS:
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PREPARED BY:

RLH

DATE: 06-26-18

SCALE: AS NOTED



COVER SHEET & LOCATION PLAN TABLE OF CONTENTS

- AO RENDERED VIEW
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- A11 EXISTING SITE VEGETATION & GRADE
- A12 LANDSCAPE PLAN PROPOSED



PROJECT NAME:

NEW 2-STOREY SINGLE FAMILY RESIDENCE

PROJECT ADDRESS:

105 LILLY STREET

HAPEVILLE, GA 30354

PROJECT DESCRIPTION:

SINGLE FAMILY CONSTRUCTION
3 BEDROOMS, 3 1/2 BATH

HARDI PLANK SIDING, BRICK FRONT

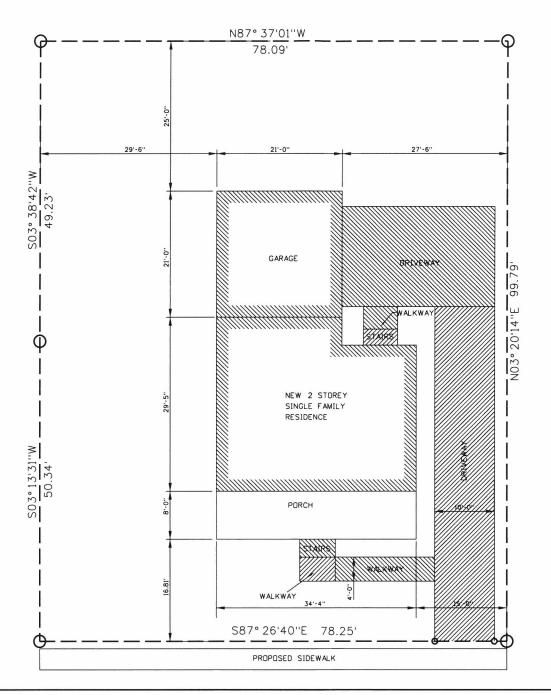
DESIGNER:

PROPERTY CLASSIFICATION: R3-RESIDENTIAL (IBC)

ZONING: R1

APPLICABLE CODES:

LIVING AREA FIRST FLOOR 922 SF LIVING AREA SECOND FLOOR 1068 SF TOTAL LIVING AREA 1990 SF GARAGE AREA 442 SF BUILDING HEIGHT 32'5" LOT AREA 7799 SF (0.18 AC)





VICINITY/CONCEPTUAL MAP



LILLY STREET

INTERNATIONAL BUILDING CODE, 2012 EDITION, WITH GEORGIA AMENDMENTS INTERNATIONAL RESIDENTIAL CODE, 2012 EDITION, WITH GEORGIA AMENDMENTS INTERNATIONAL MECHANICAL CODE, 2012 EDITION, WITH GEORGIA AMENDMENTS INTERNATIONAL PLUMBING CODE, 2012 EDITION, WITH GEORGIA AMENDMENTS INTERNATIONAL FUEL GAS CODE, 2012 EDITION, WITH GEORGIA AMENDMENTS INTERNATIONAL FIRE CODE, 2012 EDITION, WITH GEORGIA AMENDMENTS INTERNATIONAL FIRE CODE, 2012 EDITION, WITH GEORGIA AMENDMENTS

INTERNATIONAL FIRE CODE, 2012 EDITION, WITH GEORGIA AMENDMENTS
INTERNATIONAL FIRE CODE, 2012 EDITION, WITH GEORGIA SUPPLEMENTS AND AMENDMENTS

NFPA NATIONAL ELECTRICAL CODE, 2014 EDITION

2012 NFPA 101 LIFE SAFETY CODE WITH ALL GEORGIA STATE AMENDMENTS

LOCATION PLAN

1/16" = 1'-0"

LOT COVERAGE
BLDG 1667 SF
DRIVEWAY 950 SF
WALKWAYS 114 SF
STAIRS 39 SF
PORCH 275 SF
TOTAL COVERAGE 3045 SF
PARCEL AREA 7799 SF
TOTAL COVERAGE 39.0%

OR INFORMATION CONTACT:

JAM GARCIA
, ZIP INDUSTRIAL BLVD

VILLE, GA 30354

ENGINEER:

COVER SHEET LOCATION PLAN & VICINITY MAP

105 LILLY STREET HAPEVILLE, GA 30354

REVISIONS:
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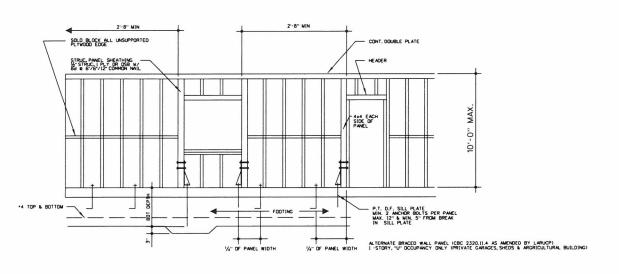
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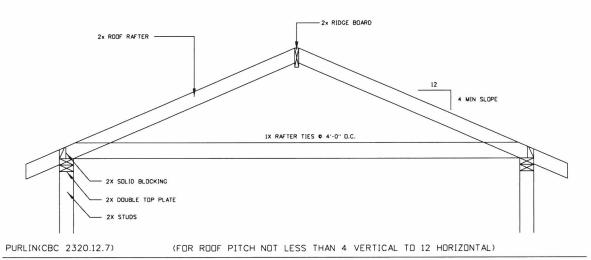
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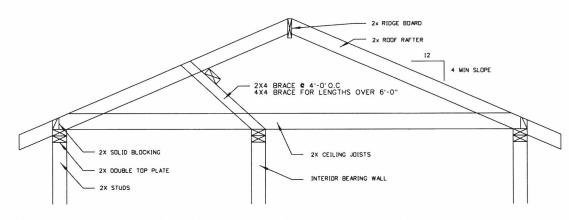
FLOOR FRAMING PLAN SECOND FLOOR
1/8"-1'-0"

FRAMING DETAILS





ROOF PITCH DETAIL



PURLIN(CBC 2320.12.7)

(FOR ROOF PITCH NOT LESS THAN 4 VERTICAL TO 12 HORIZONTAL)

25'-0" MAX. BETWEEN BEARING WALLS WITHOUT ENGINEERING

ROOF PITCH DETAIL

FOR INFORMATION CONTACT:
WILLIAM GARCIA
3515 ZIP INDUSTRIAL BLVD
HAPEVILLE, GA 30354
404-886-4857

ENGINEER:

PLAN

SHEET TITLE:
FLOOR FRAMING PLA

105 LILLY STREET
HAPEVILLE, GA 30354

REVISIONS:

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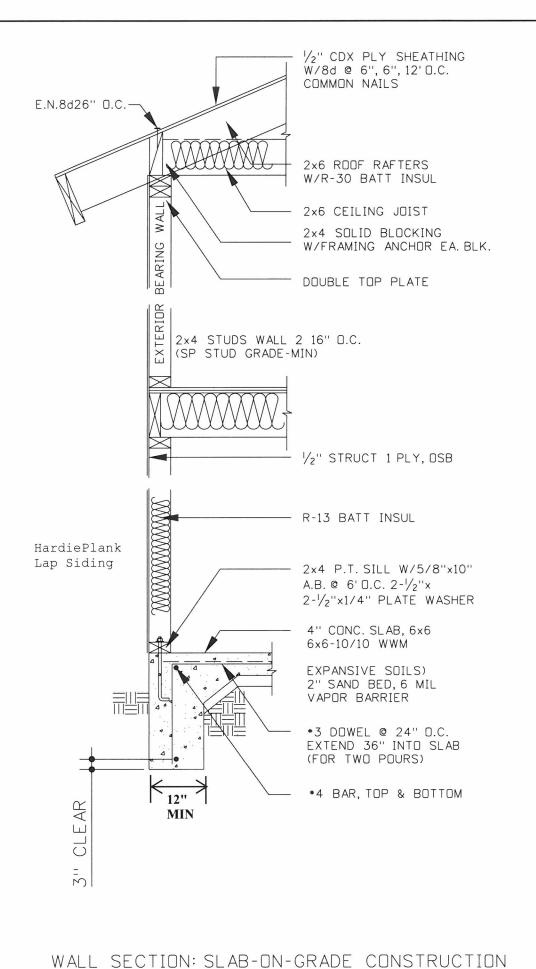
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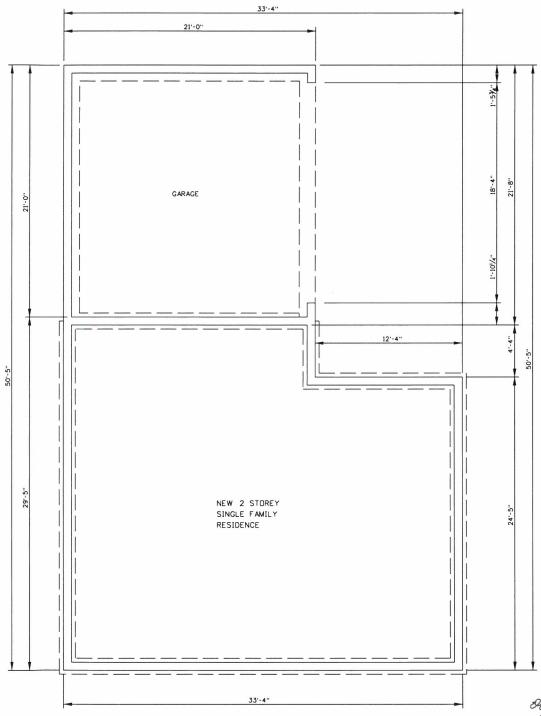
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FOUNDATION PLAN 1/8"-1'-0"

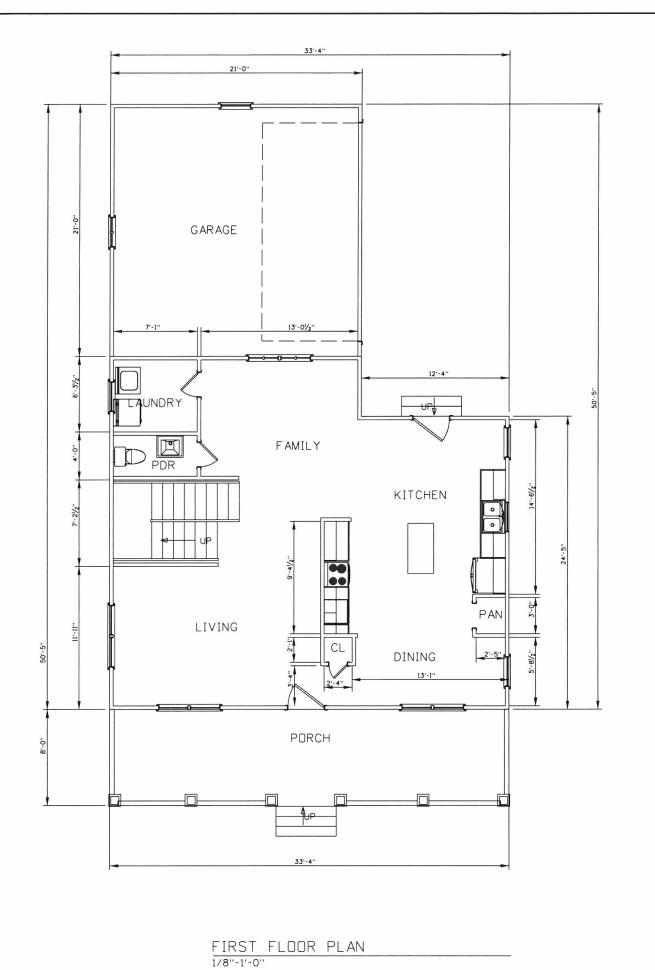
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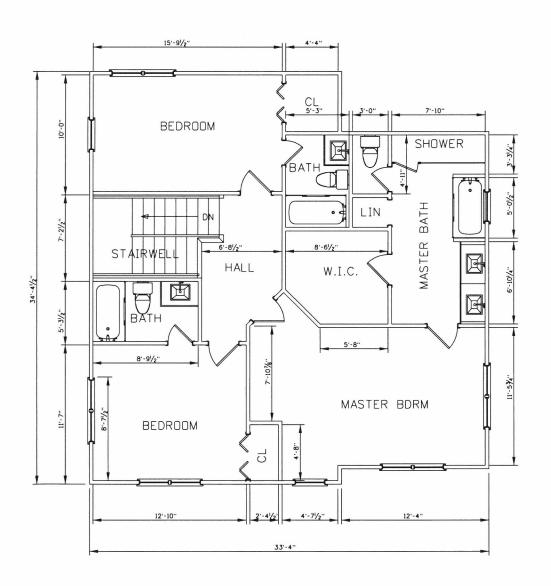
Ы FOUNDATION S DETAILS

STREET GA 30354

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SECOND FLOOR PLAN 1/8"-1'-0"



FOR INFORMATION CONTACT:
WILLIAM GARCIA
3515 ZIP INDUSTRIAL BLVD
HAPEVILLE, GA 30354
404-886-4857

ENGINEER:

FIRST & SECOND FLOOR PLANS

PROJECT LOCATION
105 LILLY STREET
HAPEVILLE, GA 30354

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DATE: 06-26-18

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FRONT ELEVATION
1/8"-1'-0"



REAR ELEVATION
1/8"=1'-0"

ITEM	DESCRIPTION
STUDS: (2X4	SOUTHERN PINE STUD GRADE
POST BEAMS AND HEADERS	SOUTHERN PINE GRADE 1
ALL OTHER HORIZONTAL	SOUTHERN PINE GRADE 2
ALL OTHER VERTICAL	SOUTHERN PINE GRADE 2
PLYWOOD:	
STRUCTURAL SHEATHING	GRADE MARKED STRUCTURAL 1
PLYCLIPS	PSC'S BY SIMPSON OR EQUAL
LAG BOLTS	ANSI/ASME B18.2.1
NAILS	COMMON FEDERAL FF-N-105B (USE GALVANIZED AT EXTERIOR LOCATIONS)
SCREWS	ANSI B18.6.1 / ASTM A502
JOIST HANGERS	SIMPSON OR EQUAL
CONNECTORS	SIMPSON OR EQUAL (USE GALVANIZED AT EXTERIOR LOCATIONS)

CEILING HEIGHT				
FIRST FLOOR	9'-0"			
SECOND FLOOR	8'-0"			
BEDS/BATHS				
BEDROOMS:	3			
FULL BATHROOMS:	3			
HALF BATHROOMS:	1			
EXTERIOR WALLS	5			
STANDARD TYPE(S):	2X4			
OPTIONAL TYPE(S):	2X6			
FOUNDATION TYPE	PE			
STANDARD FOUNDATIONS:	SLAB ON GRADE			



FOR INFORMATION CONTACT:
WILLIAM GARCIA
3515 ZIP INDUSTRIAL BLVD
HAPEVILLE, GA 30354
404-886-4857

ENGINEER:

EXTERIOR
FRONT & REAR
ELEVATIONS

105 LILLY STREET HAPEVILLE, GA 30354

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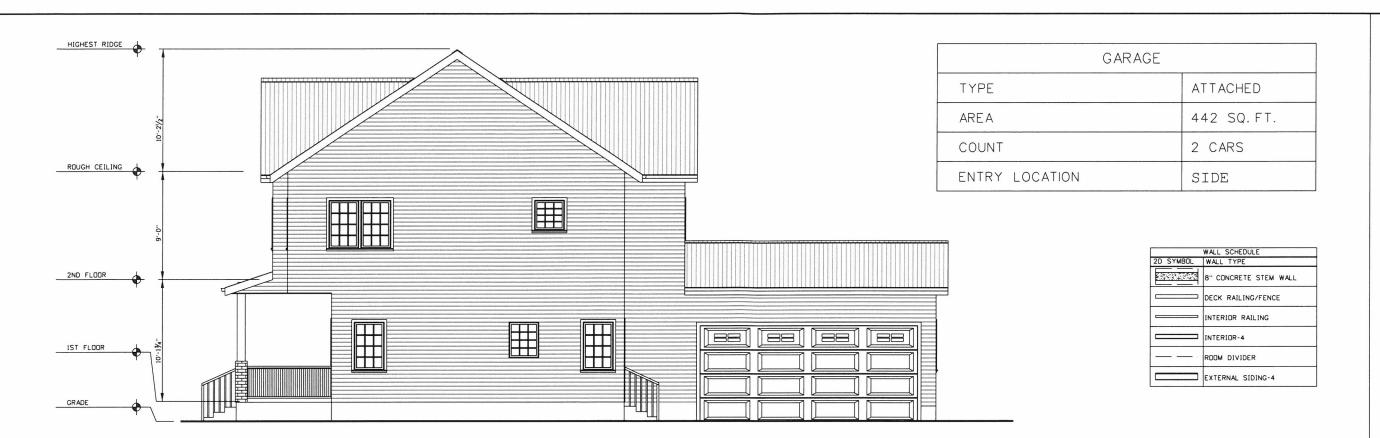
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A5







LEFT ELEVATION
1/8"-1'-0"



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3515 ZIP INDUSTRIAL BLVD
HAPEVILLE, GA 30354
404-886-4857

ENGINEER:

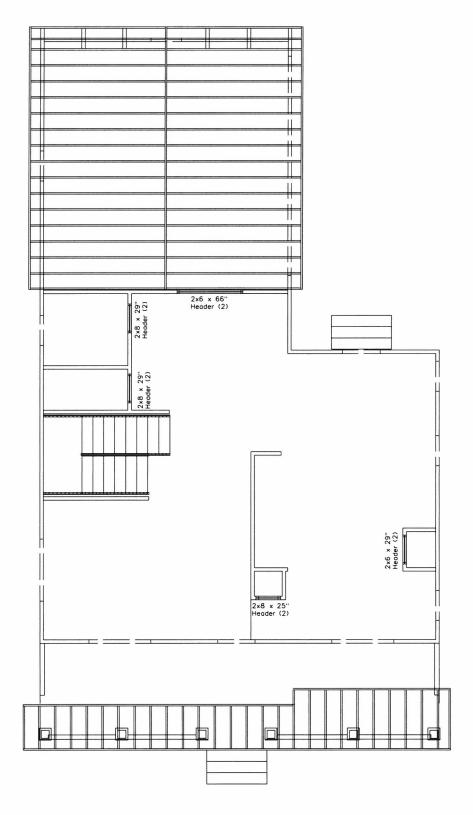
EXTERIOR RIGHT & LEFT ELEVATIONS

105 LILLY STREET HAPEVILLE, GA 30354

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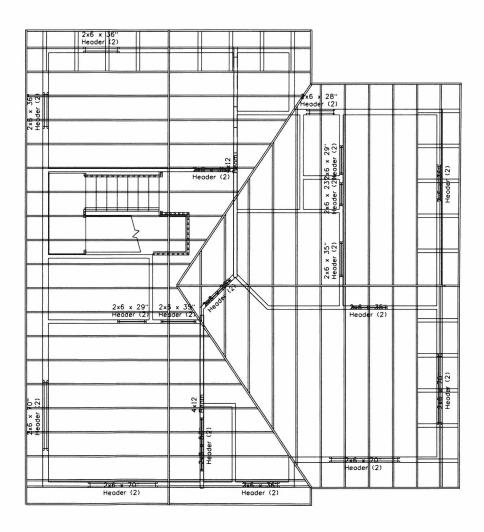


ROOF FRAMING PLAN 1ST FLOOR
1/8"-1'-0"

SOUTHERN PINE SPAN TABLES

MAXIMUM SPANS GIVEN IN FEET AND INCHES INSIDE TO INSIDE OF BEARINGS

		RAFTER	RS - 20 PS	F LIVE LOA	O, 15 PSFD6	AD LOAD, 2	40 DEFLECT	TION, CD -	1.25		
SIZE	SPACING		GRADE								
			VISUALLY GRA	NOED		MACHINE	E STRESS RATE	D (MSR)	MACHINE	EVALUATED LU	MBER (MEL)
INCHES	INCHES ON CENTER	DSS	No.1	No.2	No.3	24001 · 2.0E	1650f - 1.5E	1500f - Let	W-14 (1800-1.7)	N-29 (1560-1.7)	N-12 (1600-L6)
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ROOF FRAMING PLAN 2ND FLOOR 1/8"-1'-0"

ROOF FRAMING NOTES

ROOF FRAMING DRAWING IS FOR ILLUSTRATION ONLY.

ALL ROOF FRAMING 24" O.C.

ALL OVERHANGS 18".

FOR INFORMATION CONTACT:
WILLIAM GARCIA
3515 ZIP INDUSTRIAL BLVD
HAPEVILLE, GA 30354
404-886-4857

ENGINEER:

ENGINEER:

ROOF FRAMING PLAN

105 LILLY STREET HAPEVILLE, GA 30354

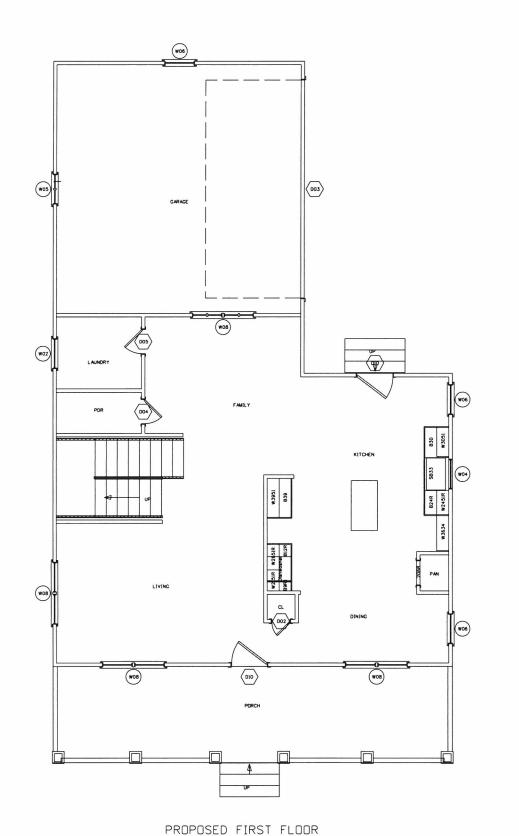
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PREPARED BY:

RLH

DATE: 06-26-18

SCALE: AS NOTED





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	(0)		
eow		MASTER BORM (W07	,
	BECHOOM WOD	012 5 W07	

PROPOSED SECOND FLOOR



SHEET TITLE:	DOOR & WINDOW SCHEDULE
_	
LOCATION	STREET ., GA 30354

BLVD

WILLIAM GARCIA 3515 ZIP INDUSTRIAL E HAPEVILLE, GA 30354 404-886-4857

ENGINEER:

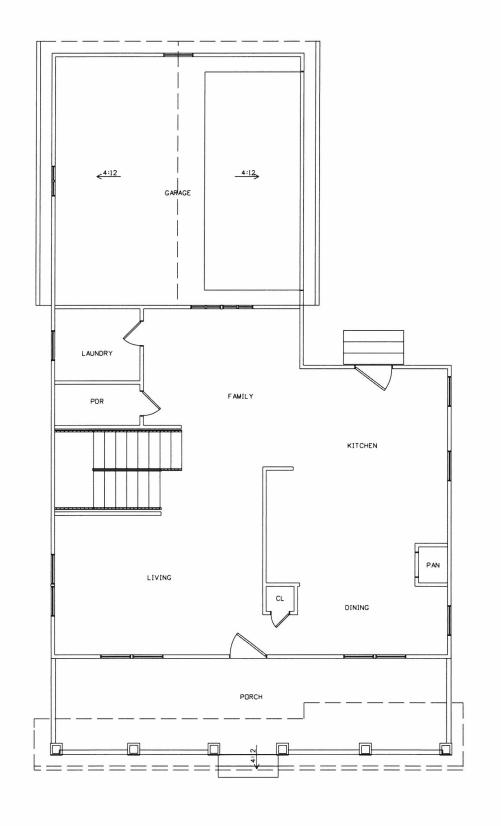
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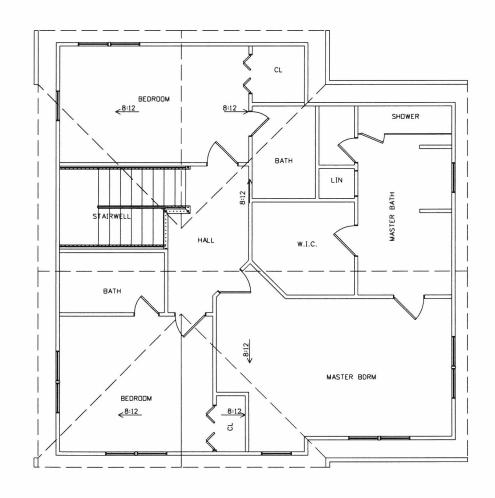
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DATE:	06-26-18
SCALE:	AS NOTED

SHEET No.	
A8	







PROJECT LOCATION

PROJECT LOCATION

105 LILLY STREET

HAPEVILLE, GA 30354

REVISIONS:
No. DATE
1
2
3

ENGINEER:

PLAN

ROOF

PREPARED BY:

RLH

DATE: 06-26-18

SCALE: AS NOTED

SHEET No.

ROOF PLAN 1ST FL

ROOF PLAN 2ND FL 1/8"+1'-0"

NOTES AND SPECIFICATIONS

PROJECT SUMMARY:

CONSTRUCTION OF A NEW SINGLE FAMILY HOUSE.

105 LILLY STREET, HAPEVILLE, GA 30354

GENERAL
ALL WORK PERFORMED BY THE CONTRACTOR SHALL CONFORM TO THE REQUIREMENTS OF MUNICIPAL, LOCAL OR FEDERAL AND STATE LAWS AS WELL AS ANY OTHER GOVERNING REQUIREMENTS, WHETHER OR NOT SPECIFIED ON THE DRAWINGS.

WHERE THE CONTRACT NOTES OR DRAWINGS CALL FOR ANY WORK OF A MORE STRINGENT NATURE THAN THAT REQUIRED BY THE BUILDING CODE OR ANY OTHER DEPARTMENT HAVING JURISDICTION OVER THE WORK, THE WORK OF THE MOST STRINGENT NATURE CALLED FOR BY THE CONTRACT, CONSTRUCTION NOTES, OR DRAWINGS SHALL BE FURNISHED IN ALL CASES.

THE CONTRACTOR SHALL OBTAIN AND PAY FOR ALL LEGALLY REQUIRED APPROVALS AND PERMITS NECESSARY FOR THE EXECUTION AND COMPLETION OF HIS WORK, FORWARD COPIES OF EXECUTED PERMITS TO OWNER.

ALL DRAWINGS AND ALL CONSTRUCTION NOTES ARE COMPLEMENTARY, AND WHAT IS CALLED FOR BY EITHER WILL BE BINDING AS IF CALLED FOR BY ALL. ANY WORK SHOWN OR REFERRED TO ON ANY ONE SET OF DRAWINGS SHALL BE PROVIDED AS THOUGH SHOWN ON ALL RELATED

THE CONTRACTOR IS WHOLLY RESPONSIBLE FOR THE COORDINATION AND SCHEDULING OF THE WORK OF ALL SUBCONTRACTORS CRAFTSMEN AND TRADESMEN REQUIRED TO COMPLETE THE JOB.

THE CONTRACTOR SHALL NOTIFY DWNER IMMEDIATELY IF HE CANNOT COMPLY WITH ALL REQUIREMENTS CALLED FOR ON THESE DRAWINGS

THE CONTRACTOR SHALL NOTIFY OWNER IMMEDIATELY OF ANY DISCREPANCIES OR OMISSIONS BETWEEN THE DRAWINGS, THESE NOTES AND SPECIFICATIONS, AND FIELD CONDITIONS, AND REQUEST CLARIFICATION

CONTRACTOR SHALL CHECK AND VERIFY ALL DIMENSIONS AND CONDITIONS AT JOB SITE RELATING TO THE WORK OF ALL TRADES, NO ALLOWANCE SHALL BE MADE FOR ANY EXTRA EXPENSE OR EXTENSION OF TIME DUE TO CONTRACTOR'S FAILURE OR NEGLIGENCE IN COMPLETELY EXAMINING THE JOBSITE.

COSTS DUE TO DEFECTIVE AND/OR ILL-TIMED WORK AS A RESULT OF, BUT NOT LIMITED TO, INFERIOR WORKMANSHIP OR MATERIALS AND/OR IMPROPER SCHEDULING OR DELINQUENT ORDERING SHALL BE BORNE BY THE

DUMPSTERS OR ANY ONSITE DISPOSAL EQUIPMENT MAY NOT BE LOCATED ON THE STREET.

THE CONTRACTOR SHALL REMOVE ALL RUBBISH AND WASTE MATERIALS FROM HIS AND HIS SUBCONTRACTOR'S WORK AND DISPOSE OF THESE AT APPROPRIATE WASTE MANAGEMENT FACILITIES AT HIS COST.

THE CONTRACTOR SHALL EXERCISE STRICT DUST CONTAINMENT AND DUST CONTROL TO PREVENT DIRT OR DUST FROM LEAVING THE JOBSITE AND TO MINIMIZE CONTAMINATION OF DUCTS AND AIR HANDLING EQUIPMENT.

SHOULD THE CONTRACTOR DAMAGE ANY NEW OR EXISTING CONSTRUCTION, STRUCTURE, OR EQUIPMENT HE SHALL REPAIR OR REPLACE THESE AT HIS COST TO THE SATISFACTION OF AND AT NO COST TO THE OWNER.

THE CONTRACTOR SHALL PROVIDE ALL NECESSARY PROTECTION FOR HIS WORK AND THE PREMISES UNTIL COMPLETION OF CONTRACTED WORK.

THESE DRAWINGS, NOTES, AND SPECIFICATIONS CONVEY THE DESIGN INTENT. THE CONTRACTOR SHALL USE THE HIGHEST POSSIBLE QUALITY OF WORKMANSHIP, NEW MATERIAL, AND EQUIPMENT IN PERFORMING THE WORK.

THE CONTRACTOR SHALL MAINTAIN A CURRENT AND COMPLETE SET OF CONSTRUCTION PLANS ON SITE FOR USE OF ALL HIS SUBCONTRACTORS AND TRADESMEN AND SHALL BE RESPONSIBLE FOR COORDINATING THEIR WORK.

THE CONTRACTOR SHALL COOPERATE WITH THE OWNER IN SCHEDULING AND RESOLVING SCHEDULE AND OTHER CONFLICTS WITH OTHER CONTRACTORS HIRED BY THE DWNER TO PERFORM OTHER WORK AT THE SITE.

THE CONTRACTOR SHALL AS NEEDED ADJUST OR REFURBISH EXISTING MANUFACTURED ITEMS NOT BEING REMOVED AND TIGHTEN ANY LODSE ITEMS SUCH AS EXIT SIGNS, ALARMS, FIRE EXTINGUISHER CASES, SPEAKERS, MOLDINGS AND DOOR HARDWARE

CONTRACTOR SHALL ACQUIRE INSURANCE AND BONDING AS DIRECTED TO THE SATISFACTION OF THE DWNER AND PROVIDE PROOF OF SUCH TO THE DWNER.

THE CONTRACTOR SHALL VERIFY SIZE, LOCATION, ELECTRICAL REQUIREMENTS AND CHARACTERISTICS OF ALL WORK AND/OR EQUIPMENT SUPPLIED BY THE OWNER OR OTHERS PRIOR TO THE START OF RELATED WORK WITH THE MANUFACTURER OR SUPPLIER

THE DWNER MAY ORDER EXTRA WORK WITHOUT INVALIDATING THE CONTRACT. THE CONTRACTOR SHALL BE PAID EXTRA FOR SUCH WORK AT NEGOTIATED PRICES AND AGREED UPON EXTRA TIME TO COMPLETE IF NECESSARY.

UNLOADING CHARGES FOR ALL MATERIAL AND EQUIPMENT NECESSARY FOR AND / OR TO BE INCORPORATED INTO THE WORK.

THE ESSENCE IN THE CONTRACT AND CONTRACTOR SHALL SUBMIT A DETAILED SCHEDULE OF WORK THROUGH COMPLETION.

EXCEPT WHERE OTHERWISE INDICATED, DIMENSIONS ARE FROM FACE OF FINISH TO FACE OF FINISH.

ALL MATERIALS AND WORKMANSHIP SHALL BE GUARANTEED FOR A PERIOD OF ONE YEAR AFTER SUBSTANTIAL COMPLETION OF WORK

DUCTS AND DUTLETS SHALL BE SEALED WITH AN ACQUISTICAL SEALANT AND CONCEALED OR RECESSED FIXTURES SHALL BE COVERED OR BACKED WITH A

THE CONTRACTOR SHALL PROVIDE BLOCKING, BACKING, FRAMING HANGERS, OR DTHER SUPPORT FOR ALL FIXTURES, EQUIPMENT, CABINETRY, FURNISHINGS, AND ALL OTHER ITEMS AS REQUIRED.

DOOR OPENINGS IN GYPSUM BOARD PARTITIONS NOT DIMENSIONED ARE LOCATED IN CENTER OF ROOM OR WITHIN 4" OF ADJOINING PARTITION.

ALL ITEMS ARE NEW UNLESS NOTED OTHERWISE

CONTRACTOR SHALL ENSURE THAT INSTALLATION METHODS CONFORM TO ALL APPLICABLE BUILDING CODES.

THE CONTRACTOR SHALL VERIFY REQUIRED LOCATION OF ALL NECESSARY ACCESS PANELS ON PARTITIONS, FLOORS, OR CEILINGS AND COORDINATE EXACT LOCATIONS WITH DWNER BEFORE INSTALLATION

CONTRACTOR SHALL SWEEP FLOOR AREA IN ADVANCE OF FLOOR OR WINDOW COVERING OR CABINET INSTALLATION EVEN IF THESE ARE TO BE DONE BY

CONTRACTOR SHALL SECURE THE BUILDING AT THE CLOSE OF WORK EACH DAY.

BY ENTERING INTO AN AGREEMENT WITH THE DWNER, THE CONTRACTOR REPRESENTS THAT HE HAS VISITED THE JOB SITE, FAMILIARIZED HIMSELF WITH EXISTING CONDITIONS AND NOTED ANY DISCREPANCIES WITH THE CONTRACT DRAWINGS AND OTHER DOCUMENTS.

CONTRACTOR SHALL BRING ANY DISCREPANCIES TO THE DWNER'S ATTENTION PRIOR TO PROCEEDING AND MAY SUBMIT PROPOSAL FOR RESOLVING ALONG

ADDITIONAL COST OR COST REDUCTION DETAILS IF APPLICABLE.

THE CONTRACTOR SHALL CLEAN THE WORK AND PREMISES PRIOR TO

THE CONTRACTOR SHALL DEFEND AND HOLD HARMLESS THE ENGINEER, THE DWNER AND OWNER'S AGENTS AND REPRESENTATIVES FROM ANY LEGAL ACTION RESULTING FROM THE CONTRACTOR'S CONDUCT OF THE WORK.

CONTRACTOR SHALL SUBMIT SAMPLES OF EXTERIOR AND INTERIOR MATERIALS INCLUDING DOOR HARDWARE AND FINISHES TO THE DWNER FOR APPROVAL TO INSTALLATION.

CONTRACTOR SHALL OBTAIN ALL REQUIRED PERMITS INCLUDING MECHANICAL, FLECTRICAL, AND PLUMBING WORK AS NECESSARY, THE CONTRACTOR SHALL FURNISH AND INSTALL ALL PARTITIONS INDICATED ON THE DRAWINGS.

PARTITIONS SHOWN ALIGNED WITH EXISTING BASE BUILDING ELEMENTS SHALL BE INSTALLED FLUSH AND SMOOTH WITH BASE BUILDING ELEMENTS

CONTRACTOR SHALL REPAIR, REPLACE OR MODIFY ANY FIXTURE, STRUCTURE, WALL, CEILING, EQUIPMENT, FLOOR OR FINISH THAT REQUIRES TEMPORARY DISMANTLING, TEMPORARY REMOVAL, OR ALTERATION IN ORDER TO ACCOMMODATE THE NEW CONSTRUCTION

ACCESSIBILITY / SAFFTY

CONTRACTOR SHALL PROVIDE ANY AND ALL LIFE SAFETY EQUIPMENT AS REQUIRED BY LOCAL AND STATE CODES.

DURING CONSTRUCTION, CONTRACTOR SHALL PROVIDE NOT LESS THAN ONE PORTABLE FIRE EXTINGUISHER RATED AT LEAST 2-A AT EACH STAIRWAY ON

FLOOR LEVELS WHERE COMBUSTIBLE MATERIALS HAVE ACCUMULATED.

LIGHT AND CONTROL SWITCHES SHALL BE MOUNTED NOT MORE THAN 4'-0" ABOVE THE FLOOR OR WORKING PLATFORM

DOOR HANDLES, PULLS, LATCHES, LOCKS AND OTHER OPERATING DEVICES SHALL BE INSTALLED 34 INCHES MINIMUM AND 48 INCHES MAXIMUM ABOVE THE FINISHED FLOOR. (LOCKS USED ONLY FOR SECURITY PURPOSES AND NOT USED FOR NORMAL OPERATION ARE PERMITTED AT ANY HEIGHT.)

DOOR CLOSERS AND STOPS SHALL NOT REDUCE HEADROOM TO LESS THAN 78

INTERIOR WALL AND CEILING FINISHES CLASSIFIED IN ACCORDANCE WITH SHALL BE AS FOLLOWS: (TESTING IN ACCORDANCE WITH ASTM E-84 OR FLAME SPREAD INDEX NOT GREATER THAN 200. SMOKE-DEVELOPED INDEX NOT GREATER THAN 450.

ALL EXHAUST FANS TO BE VENTED DIRECTLY TO THE EXTERIOR

ALL PENETRATIONS OF THE BUILDING ENVELOPE SHALL BE SEALED WITH CAULK OR FOAM.

ALL COMBUSTION APPLIANCES WILL BE VENTED DIRECTLY TO THE EXTERIOR.

FURNACE FIREBOX SHALL HAVE OUTSIDE COMBUSTION AIR SUPPLY PURSUANT

CYPSUM BOARD THICKNESS AND APPLICATION SHALL CONFORM TO IRC TABLE

ALL FRAMING LUMBER SHALL BE SOUTHERN PINE GRADE 2 OR BETTER UNLESS

ATTIC ACCESS SHALL BE:

A MINIMUM DE 22" X 36" THERE SHALL BE 30" MIN. CLEARANCE AT DR ABOVE THE OPENING LOCATED IN A CORRIDOR, HALLWAY OR OTHER READILY ACCESSIBLE LOCATION. ATTICS WITH A MAXIMUM VERTICAL HEIGHT OF LESS THAN 30" WILL NOT REQUIRE ACCESS OPENINGS.

VENTILATION

ATTIC SHALL HAVE VENTILATION EQUAL TO 1 SQUARE FOOT PER 150 SQ.
FEET OF ATTIC SPACE, VENTILATION SHALL BE PROTECTED FROM SNOW AND RAIN AND SHALL BE COVERED WITH GALVANIZED WIRE SCREEN OPENINGS SHALL BE LOCATED TO PROVIDE CROSS VENTILATION.

UNDER FLOOR SPACES SHALL HAVE VENTILATION EQUAL TO ONE SQ. FOOT PER 150 SO FEET

OF FLOOR SPACE, VENTS SHALL BE CAST INTO THE CONCRETE STEM WALLS AND COVERED WITH GALVANIZED WIRE SCREEN, VENTS SHALL BE LOCATED TO PROVIDE CROSS VENTILATION.

RATI ING NOTES:

STAIRWAYS SHALL HAVE A MIN. WIDTH OF 34". HAND RAILS MAY ENCROACH A MAX. DF 3" INTO THE REQUIRED WIDTH.

TREADS SHALL HAVE A MIN. WIDTH OF 9". STAIR TREADS MUST BE UNIFORM AND CAN NOT VARY FROM THE LARGEST TO THE SMALLEST BY MORE THAN 3/9".

STAIRWAYS SHALL HAVE MIN. 6'-8" OF HEADROOM AT THE NOSE OF THE

ENCLOSED USABLE SPACE UNDER INTERIOR STAIRS SHALL BE PROTECTED ON THEENCLOSED FACE WITH "TYPE" X" FIRE-RESISTANCE RATED GYPSUM WALL

STAIRWAYS SHALL HAVE AT LEAST ONE HANDRAIL LOCATED 34" TO 38" ABOVE THE NOSING OF TREADS AND LANDINGS. THE HAND GRIP PORTION OF HANDRAILS SHALL NOT BE LESS THAN 1-1/2" OR GREATER THAN 2" IN

HANDRAILS SHALL BE CONTINUOUS THE FULL LENGTH OF THE STAIRS. THE ENDS OFHANDRAILS SHALL RETURN TO WALL OR TERMINATE INTO A NEWEL POST OR SAFETY TERMINAL.

STAIRWAYS HAVING LESS THAN 2 RISERS DO NOT REQUIRE A HAND RAIL.

34" MIN. HEIGHT GUARDRAILS SHALL BE PROVIDED FOR ALL PORCHES, DECKS, BALCONIES, STAIRWAYS AND LANDINGS WHERE THE ADJACENT SURFACE IS GREATER THAN 24" BELOW.

RAILING AND GUARDRAIL BALUSTER SPACING SHALL BE NOT GREATER THAN

THE TRIANGULAR OPENINGS FORMED BY THE RISER, TREAD, AND BOTTOM OF GUARDRAIL SHALL NOT ALLOW A 6" DIAMETER SPHERE TO PASS THROUGH.

CONCRETE NOTES

1. ALL BACKFILL AND SOIL BELOW SLABS AND FOOTINGS MUST BE COMPACTED TO 2000 PSE MIN

2. FOUNDATION CONTRACTOR IS TO PROVIDE 1/2" \star 10" ANCHOR BOLTS AT 72" O.C. AND 12" FROM CORNERS AT ALL PERIMETER FOUNDATION WALLS AND ALL BEARNG WALLS

3. CONTRACTOR RESPONSIBLE FOR ALL REINFORCEMENT IN CONCRETE WALLS AND BELOW SLAB WHERE REDUIRED. ALL REINFORCEMENT IS TO MEET LOCK CODES AND MAY REQUIRE INSPECTION BY BUILDING DEPARTMENT OFFICIALS.

4. ALL CONCRETE TO BE 3000 PSICOMPRESSIVE STRENGTH WITH 4" MAX SLUMP

STEEL REINFORCMENT WALLS UNDER 4'-0"

4 REBAR VERT AT 48" O/C

4 REBAR HORIZ, AT 24' O/C

WALLS OVER 4'-0"

4 REBAR VERT, & HORIZ, AT 18' O/C

•4 REBAR CONTINUOUS

LANDSCAPING NOTES

HYDRANGEA PANICULATA

GENUS: HYDRANGEA

SPECIES: PANICULATA

ZONE: 4-9

BLOOMS: MID SUMMER - EARLY FALL

PLANT HEIGHT: 6 FT - 7 FT

PLANT WIDTH: 4 FT - 5 FT

THRIVES IN FULL SUN TO PART SHADE, PLANT IN MOIST, RICH SOIL.IF PLANTED IN THE SUMMER, USE A LOT MORE WATER IN THE BEGINNING TO ESTABLISH THE ROOT SYSTEM, PLACE A TWO-INCH THICK LAYER OF MULCH THAT EXTENDS AT LEAST TO THE DRIP LINE TO CONSERVE MOISTURE IN THE SOIL AND KEEP SOIL TEMPERATURES EVEN. KEEP MULCH AWAY CUNSERVE MUISIONE IN THE SUIL AND KEEP SUIL TEMPERATURES EVEN. KEEP MOLCH AWAY. FROM THE STEMS OF THE PLANT WATER DEEPLY ONCE A WEEK - MORE, IF THE WEATHER IS PARTICULARLY HOT OR DRY. PROVIDE THE EQUIVALENT OF ONE INCH OF RAINFALL WEEKLY, ESPECIALLY DURING THE FIRST YEAR AFTER PLANTING. A THOROUGH WATERING ONCE WEEKLY IS BETTER THAN MORE FREQUENT, LIGHT APPLICATIONS.

FOLLOW THIS MAINTENANCE SCHEDULE FOR A FEW SEASONS AT A MINIMUM, DR LONGER IF STRESSFUL CONDITIONS, SUCH AS DROUGHT DCCUR.

PRINE IN LATE WINTER TO KEEP THE PLANTS FROM BECOMING OVERGROWN AND ENCOURAGE MORE NEW GROWTH, MORE FLOWER BUDS, AND LARGER BLOOMS, REMOVE DEAD FLOWERS, AS SOON AS THEY BECOME UNATTRACTIVE AND CLEAN UP THE OVERALL SHAPE OF THE PLANT.

EASTERN REDBUC

GENUS: CERCIS

SPECIES: CANADENSIS

ZONE: 4-9

BLOOMS: EARLY SPRING - LATE SPRING

PLANT HEIGHT: 15 FT - 25 FT

PLANT WIDTH: 15 FT - 25 FT

BEST PLANTED IN EARLY SPRING IN A MOISTURE-RETENTIVE, WELL-DRAINED SOIL DIG A HOLE THAT IS AT LEAST THREE TIMES AS WIDE AS THE RODT. BE SURE THAT THE RODT BALL IS EVEN WITH THE GROUND WHEN YOU PLACE THE TREE IN THE HOLE. DNCE PLACED IN THE GROUND, BE SURE THAT IT IS STRAIGHT AND BACKFILL HOLE WITH NATIVE SOIL. WATER THOROUGHLY AFTER PLANTING.

TO RETAIN MOISTURE, PLACE ABOUT 3 INCHES OF MULCH AROUND THE TREE OUT TO THE DRIP LINE OF THE LIMBS BUT NOT TOUCHING THE TRUNK, MULCH AFTER PLANTING AND AGAIN EACH SPRING FOR AT LEAST THE FIRST TWO YEARS. PRUNE ONLY TO SHAPE OR TO REMOVE DEAD

PRUNE RIGHT AFTER FLOWERING OR IN LATE FALL WHILE THE TREE IS DORMANT

KEEP THE SOIL MOIST, BUT NOT SATURATED, WHILE THE TREE IS ESTABLISHING, WATER WITH A DRIP SYSTEM IF POSSIBLE. IF PLANTED IN FULL SUN, WATER REGULARLY

DURING THE WARMER MONTHS, PROVIDE DEEP WATERING (TO A DEPTH OF 10" TO 12") ABOUT TWICE A WEEK DURING HOT, DRY SUMMERS TO ESTABLISH STRONG ROOTS, WATER IN THE EARLY MORNING, SO FOLIAGE HAS TIME TO DRY. IF A LATE FROST IS PREDICTED, COVER THE

WORK AN ALL-PURPOSE SLOW-RELEASE FERTILIZER OR RICH COMPOST INTO THE SOIL AROUND THE TREE AT THE BEGINNING OF EVERY SEASON

SUGGEST FOREST PANSY IAPPALACHIAN RED VARIETY

GRADING WILL BE PRIMARILY FOR LEVELING BEFORE CONCRETE POURING FOR BUILDING, DRIVEWAY, WALKWAY AND SIDEWALK AND FOR DIRECTING RUNDFF AWAY FROM HOUSE WHILE AS MUCH AS PRACTICABLE, MAINTAINING ORIGINAL GRADE IN AREAS DUTSIDE OF PERMANENT STRUCTURES. EARTHWORK WILL BE BALANCED WITH ON SITE MATERIALS AND 25 YARDS OF TOPSOIL FOR BUILDING AND DRIVEWAY BACKFILL

FNGINFFR:

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GARCIA INDUSTRIA E, GA 3035 -4857

WILLIAM (3515 ZIP HAPEVILLE

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REVISIONS: No. DATE 2 3

PREPARED BY: RI H DATE: 06-26-18 SCALE: AS NOTED



N87° 37'10"W 78.09' S03° 38'42"W 49.23' GRASS (TYP) S87° 26'40"E 78.25'

LILLY STREET

EXISTING SITE & CONTOURS
1/16" = 1'-0"

EXISTING 11" MAGNOLIA TO REMAIN

B 8" OAK TO REMAIN



EXISTING SITE
VEGETATION & GRADE

WILLIAM GARCIA 3515 ZIP INDUSTRIAL E HAPEVILLE, GA 30354 404-886-4857

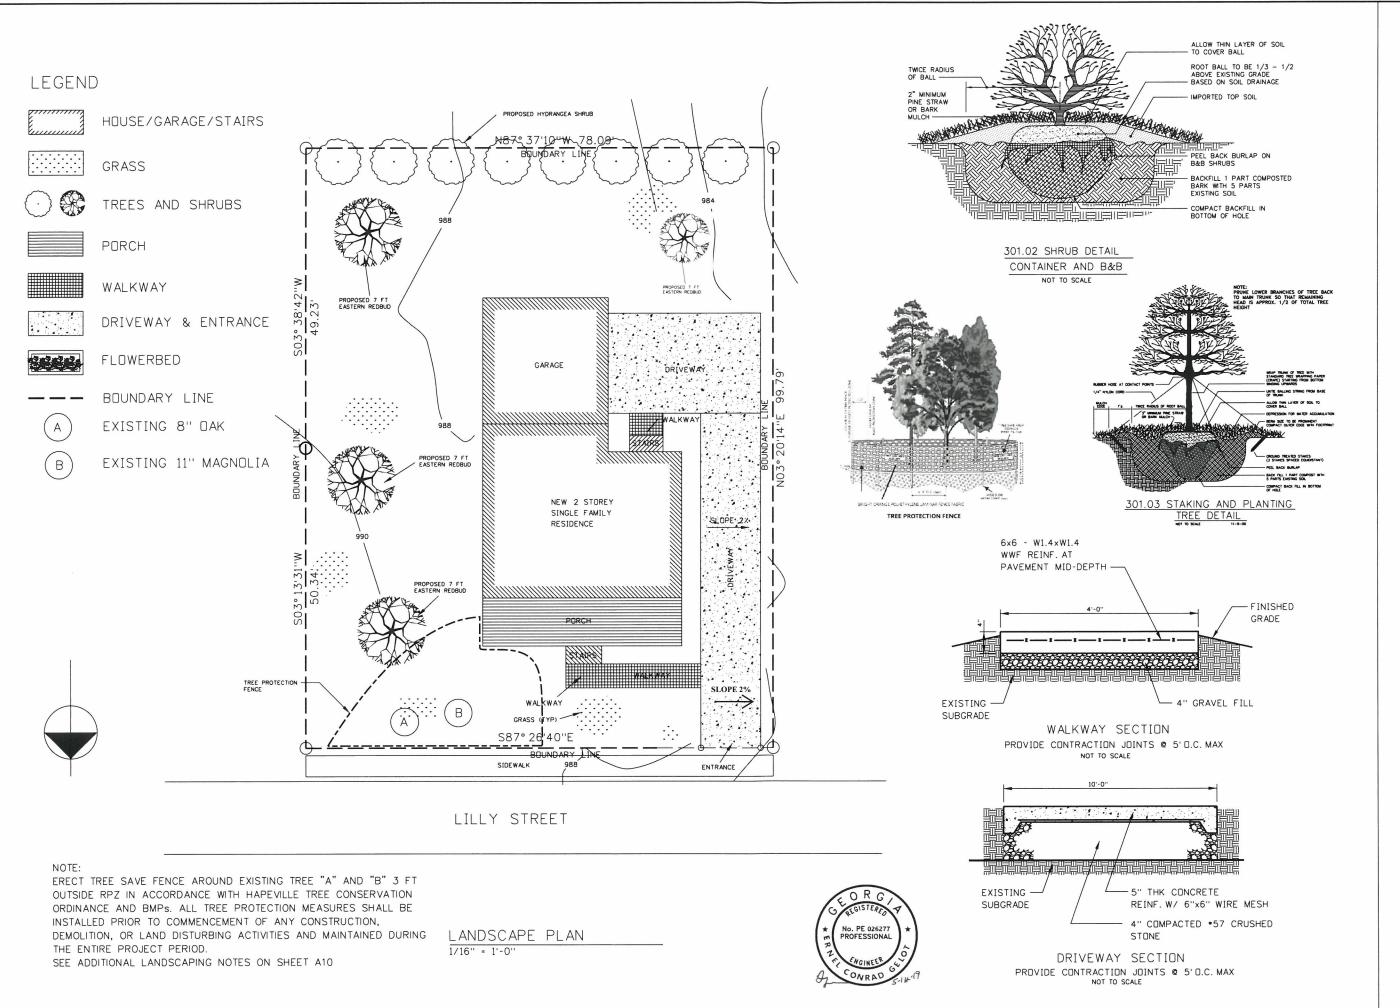
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LANDSCAPE PLAN PROPOSED

105 LILLY STREET HAPEVILLE, GA 30354

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