19-PC-07-13

# CITY OF HAPEVILLE ECONOMIC DEVELOPMENT DEPARTMENT PLANNING COMMISSION APPLICATION

Name of Applicant JANICE M WHITE
Mailing Address: 1854 VIRGINIA AUE STE 2, Callege Park GA 3033
Telephone 404) 964-5922 Mobile # Emailallpreppermit & yahou.co
Mailing Address: 1854 VIRGINIA AUE STE 2, Calege Park GA 3033  Telephone 404) 964-5922 Mobile # Emailall prepreraite yahow.co  Property Owner (s) Gustavo Perdigon 6PC UBE, LLC
Mailing Address 2505 GA fewater Ct, Cumming, GA 30040
Telephone 954-278-1687 Mobile #
Address/Location of Property: 644 Coleman Street
Parcel I.D. # (INFORMATION MUST BE PROVIDED): 14-009900031503
Present Zoning Classification: Size of Tract: O.114 acre(s)
Present Land Use: VACAUT Lot
Please check the following as it applies to this application
Site Plan ReviewConditional Use PermitTemporary Use Permit Other (Please State)
I hereby make application to the City of Hapeville, Georgia for the above referenced property. I do hereby swear or affirm that the information provided here and above is true, complete and accurate, and I understand that any inaccuracies may be considered just cause for invalidation of this application and any action taken on this application. I understand that the City of Hapeville, Georgia, reserves the right to enforce any and all ordinances. I further understand that it is my/our responsibility to conform with all of City of Hapeville's Ordinances in full. I hereby acknowledge that all requirements of the City of Hapeville shall be adhered too. I can read and write the English language and/or this document has been read and explained to me and I have full and voluntarily completed this application. I understand that it is a felony to make false statements or writings to the City of Hapeville, Georgia pursuant to O.C.G.A. 6-10-20 and may be prosecuted for a violation thereof.
Date:
Sworn to and subscribed before me  Notary Public EN SELLERS
This day of the 200. Notary Public, Fulton County, Georgia My Commission Expires June 29, 2020
Notary Public

## CITY OF HAPEVILLE ECONOMIC DEVELOPMENT DEPARTMENT PLANNING COMMISSION APPLICATION

#### **WRITTEN SUMMARY**

In detail, provide a summary of the proposed project in the space provided below. (Please type or print legibly.)

NEW CONSTRUCTION OF A SINGLE- TAMILY
HOME . 4-BED ROOMS; 3 BATHS;
Kitchen; DINING ROOM; Living Room
2 DECKSIN the rear
1/2 GARAGE
CONSTRUCTION - FALL

# CITY OF HAPEVILLE ECONOMIC DEVELOPMENT DEPARTMENT PLANNING COMMISSION APPLICATION

#### **AUTHORIZATION OF PROPERTY OWNER**

CERTIFY THAT I AM THE OWNER OF THE PROPERTY LOCATED AT:
GUSTAUD PENDIGON GACUBE CLC
644 Coleman Street
City of Hapeville, County of Fulton, State of Georgia
WHICH IS THE SUBJECT MATTER OF THIS APPLICATION. I AUTHORIZE THE APPLICANT NAMED BELOW TO ACT AS THE APPLICANT IN THE PURSUIT OF THIS APPLICATION FOR PLANNING COMMISSION REVIEW.
Name of Applicant JANICE M White
Address of Applicant NIA AUE#2, CIIEGE Park, GA 30337
Telephone of Applicant (404) 964-5922
Signature of Owner
Gustavo Pendi 608 Print Name of Owner
Personally Appeared Before Me this 1th day of 1, 2011.
Notary Public  EDDIE W SELLERS  Notary Public, Fulton County, Georgia My Commission Expires June 29, 2020

#### Site Plan Checklist – Please include with your application.

A site plan is used to determine the practical ability to develop a particular property within the City of Hapeville. Information relating to environmental condition, zoning, development impact, consistency with the Hapeville Comprehensive Plan and relevant town master plans will be considered in the decision process. To be considered, a site plan <u>must</u> contain the following information:

(Please <u>initial</u> each item on the list above certifying the all required information has been included on the site plan)



A brief project report shall be provided to include an explanation of the character of the proposed development, verification of the applicant's ownership and/or contractual interest in the subject site, and the anticipated development schedule. Please complete and submit all forms contained within the application for site plan review.



Site plans shall be submitted indicating project name, applicant's name, adjoining streets, scale, north arrow and date drawn.



The locations, size (sf) and height (ft) of all existing and proposed structures on the site. Height should be assessed from the base of the foundation at grade to the peak of the tallest roofline.



Site plans shall include the footprint/outline of existing structures on adjoining properties. For detached single-family residential infill development, the front yard setback shall be assessed based on the average setback of existing structures on adjoining lots. Where practical, new construction shall not deviate more than ten (10) feet from the average front yard setback of the primary residential structure on an adjoining lot. Exemption from this requirement due to unnecessary hardship or great practical difficulty can be approved at the discretion of the Planning Commission. To be considered for an exemption, the applicant must submit a "Request for Relief" in writing with their site plan application, including the conditions that necessitate relief (i.e. floodplain, wetland encroachment, excessive slope, unusual lot configuration, legally nonconforming lot size, unconventional sitting of adjoining structures, etc).

W

The location and general design cross-section characteristics of all driveways, curb cuts and sidewalks including connections to building entrances. A walkway from the primary entrance directly to the public sidewalk is required for all single-family residential development.

Ju

The locations, area and number of proposed parking spaces. Please refer to Article 22.1 Chart of Dimensional Requirements to determine the correct number of parking spaces for your particular type of development.

Jr.

Existing and proposed grades at an interval of five (5) feet or Jess.



The location and general type of all existing trees over six (6) inch caliper and, in addition, an identification of those to be retained. Requirements for the tree protection plan are available in Code Section 93-2-14(f). Please refer to Sec. 93-2-14(y) to determine the required tree density for your lot(s).



A Landscape Plan: The location and approximate size of all proposed plant material to be used in landscaping, by type such as hardwood deciduous trees, evergreen trees, flowering trees and shrub masses, and types of ground cover (grass, ivies, etc.). Planting in parking areas should be included, as required in Section 93-23-18.



The proposed general use and development of the site, including all recreational and open space areas, plazas and major landscape areas by function, and the general location and description of all proposed, outdoor furniture (seating, lighting, telephones, etc.). Detached single-family residential development may be exempt from this requirement.



The location of all retaining walls, fences (including privacy fences around patios, etc.) and earth berms. Detached single-family residential development may be exempt from this requirement.

The identification and location of all refuse collection facilities, including screening to be provided. Detached single-family residential development may be exempt from this requirement.

W W

4.1

Provisions for both on-site and offsite storm-water drainage and detention related to the proposed development.

Am.

Location and size of all signs. Detached single-family residential development may be exempt from this requirement.

Typical elevations of proposed building provided at a reasonable scale (1/8" = 1'0") and include the identification of proposed exterior building materials. Exterior elevations should show <u>all</u> sides of a proposed building.

Ar I

Site area (square feet and acres).

Allocation of site area by building coverage, parking, loading and driveways, and open space areas, including total open space, recreation areas, landscaped areas and others. Total dwelling units and floor area distributed generally by dwelling unit type (one-bedroom, two-bedroom, etc.) where applicable.

y

Floor area in nonresidential use by category. Detached single-family residential development may be exempt from this requirement.

Total floor area ratio and/or residential density distribution.

Number of parking spaces and area of paved surface for parking and circulation

At the discretion of the planning commission, analyses by qualified technical personnel or consultants may be required as to the market and financial feasibility, traffic impact, environmental impact, storm water and erosion control, etc. of the proposed development.

Please <u>initial</u> each item on the list above certifying the all required information has been included on the site plan, sign and submit this form with your site plan application. Failure to include this form and information required herein may result in additional delays for the consideration of your application.


Applicant Signature: Date (0/0/2019


## Residential New Construction



Atlanta, GA 30354

4 Bedroom 3 Bathroom 1944 sqft (Heated)

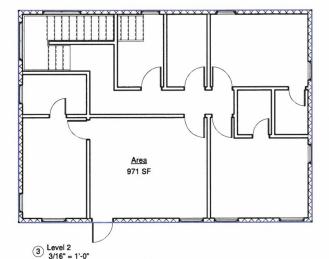

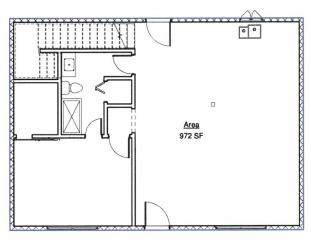

2 Foundation 3/16" = 1'-0"



GP Cube Investments

644 Colman St.

No.	Description	Dat
		_
		_
		-
		-
		-
		_
		-
		_
_		
		_
		-
_		_
_		_
		-
		-
		-
		-
		_
		-
		_

ENGINEER TAMES

Cover Sheet

Project number Project Numb
Date Issue Da
Drawn by Auth
Checked by Check

A100



4 3D View 2

Sheet Number	Sheet Name
--------------	------------

A101	Proposed Plan
A102	Elevation
A100	Cover Sheet
A103	Foundation Plan
A104	Framing Plan
A105	Roof Plan
A106	Deck Plan

Code Summary
International Residential Code, 2012 Edition,
with Georgia Amendments (2014) (2015) (2017)

# engies d AA

Investments GP Cube

.12 namloO 448

1				
-				
1				
		_		
1				
_				
L				
1				
	unndunena			

3/16" = 1'-0"

Срескег

Project Number

**f0fA** 

Proposed Plan

Family and Type Mark Door Schedule


Family and Type	Type Mark
"84 x "85 :gnuH-elduoG-wobniW	
Window-Casement-Double: 34" x 36"	
Window-Double-Hung-Double: 76" x 56"	
Window-Double-Hung: 36" x 56"	
Window-Double-Hung-Double: 56" x 52"	

ALIDOM OCHODINA	
 Family and Type	Type Mark
 Window-Double-Hung: 28" x 46"	5
Window-Casement-Double: 34" x 36"	t
Window-Double-Hung-Double: 76" x 56"	8
Window-Double-Hung: 36" x 56"	0
Window-Double-Hung-Double: 56" x 52"	5

Family and Type	Type Mark
odf i oim finim i	umu odći
Window-Double-Hung: 28" x 46"	
Window-Casement-Double: 34" x 36"	
Window-Double-Hung-Double: 76" x 56"	
Window-Double-Hung: 36" x 56"	
Window-Double-Hung-Double: 56" x 52"	

S 2/16" = 1'-0"

Door-Interior-Single-1_Panel-Wood: 28" x 80"	411
Door-Interior-Single-3_Panel_Vert-Wood: 30" x 80"	109
Door-Interior-Single-3_Panel_Vert-Wood: 30" x 80"	801
Door-Interior-Single-3_Panel_Vert-Wood: 30" x 80"	107
Door-Interior-Single-3_Panel_Vert-Wood: 30" x 80"	901
Door-Interior-Single-3_Panel_Vert-Wood: 30" x 80"	901
2_Panel_Bifold_Door_18618: 30" x 84"	104
Door-Interior-Single-1_Panel-Wood: 28" x 80"	103
Door-Interior-Single-1_Panel-Wood: 24" x 80"	86
Door-Interior-Single-1_Panel-Wood: 24" x 80"	<b>Z6</b>
Door-Interior-Single-1_Panel-Wood: 24" x 80"	96
Door-Interior-Single-1_Panel-Wood: 24" x 80"	63
Dook-Opening: 36" x 80"	68
Interior_barn_door_18732: Interior_bam_door_18732	48
Door-Interior-Single-3_Panel_Vert-Wood: 30" x 80"	98
Door-Interior-Single-Full Glass-Wood: 30" x 80"	08
Door-Interior-Single-Full Glass-Wood: 36" x 84"	LÞ
Door-Exterior-Single-Entry-Half Flat Glass-Wood_Clad: 36" x 80"	12

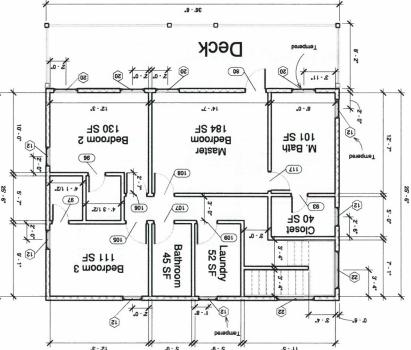



with Georgia Amendments (2014) (2015) (2017) International Residential Code, 2012 Edition, Code Summary

12.-51/5..

Bedroom 1

92 SE

Bath

11. - 8..

feild in accordance with AWPA M4. Preservative - treated lumber in contract notches and drilled holes of preservative treated wood shall be treated in the

3. All deck lumber shall be presure preservative treated in accordance with AWPA

U1 for the specied, product, preservative and end use. Feild cut ends,

4. Joist Hangers shall have a minimum capacity of 800 lbs.

2. All concrete to have 4000 psi 28-day compressive strength

with the ground shall be rated as "ground-contract."

1. All lumber to be Southern Pine No. 2 or better

General Notes

2/18-5

T-31/2"

......9

4H @ 0. - 6.

Deck

.Z/1 9 - .01

10. - 6 1/2"

Dining/ Living RS 365


-L - '0S


.8 - .96

12.-11/S

7-31/2"

1) Tevel 1

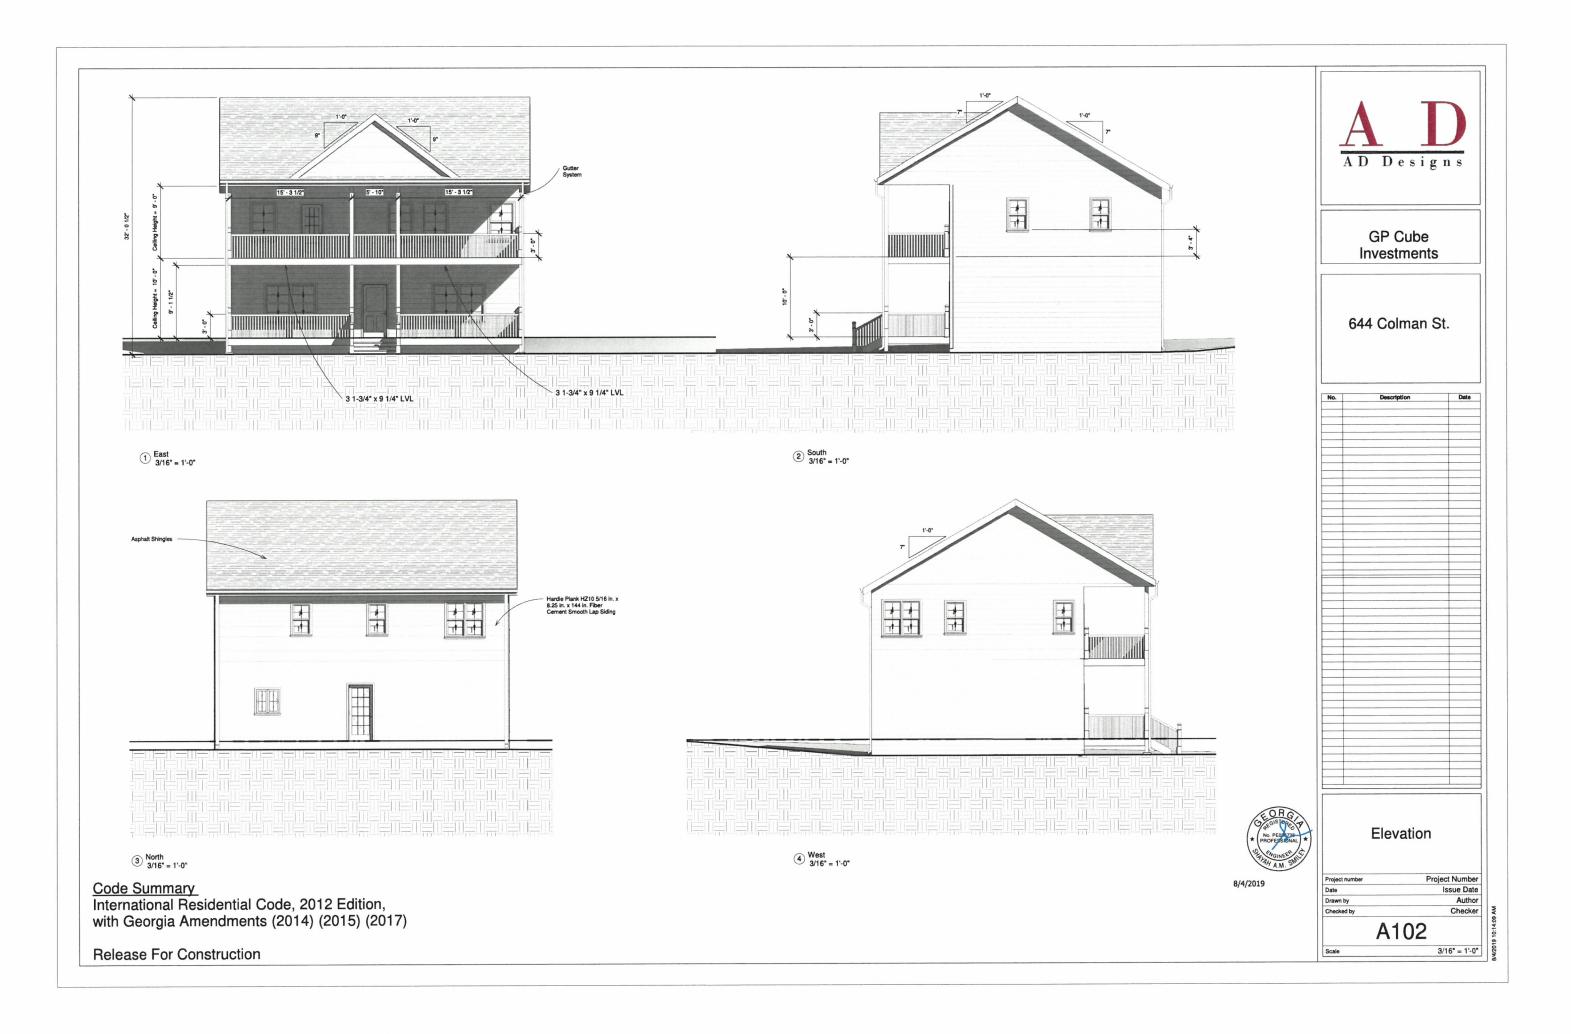


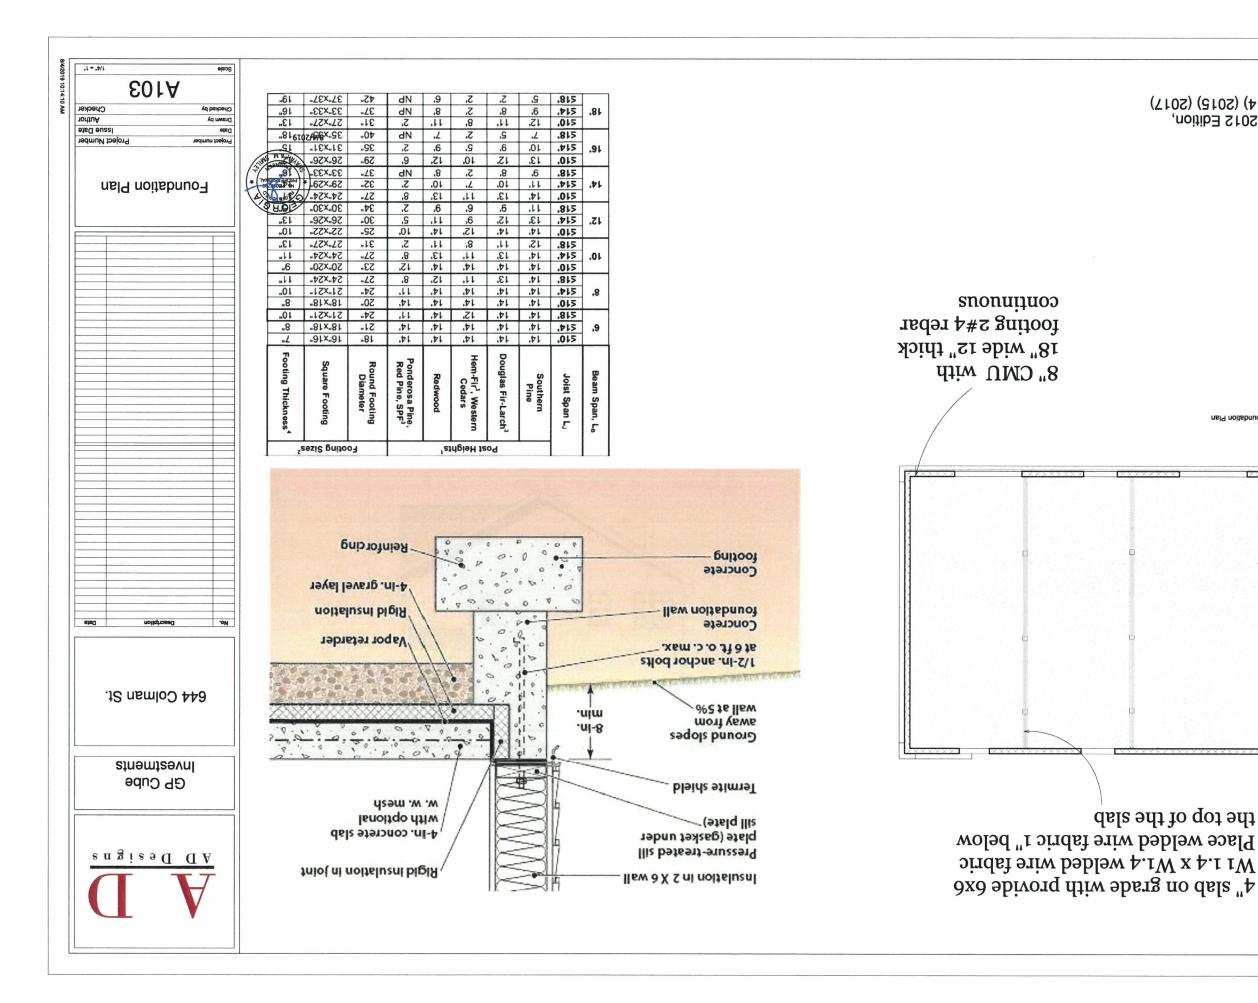


Code Summany

1) Foundation Plan

with Georgia Amendments (2014) (2015) (2017) International Residential Code, 2012 Edition,

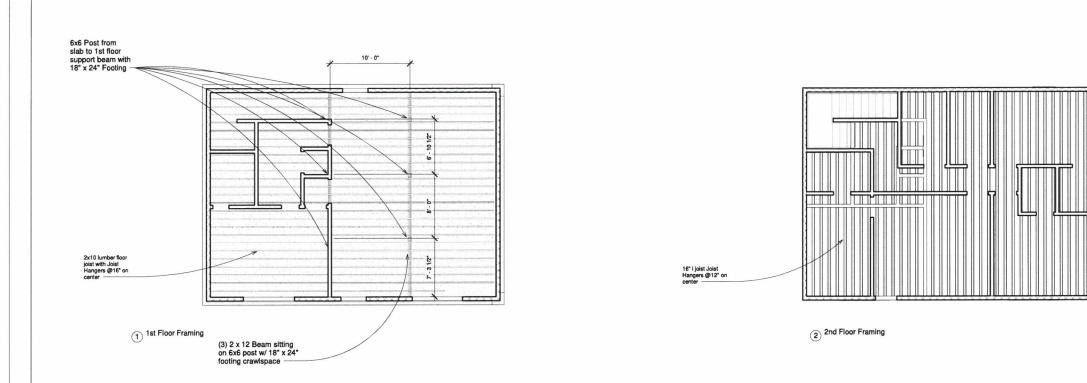

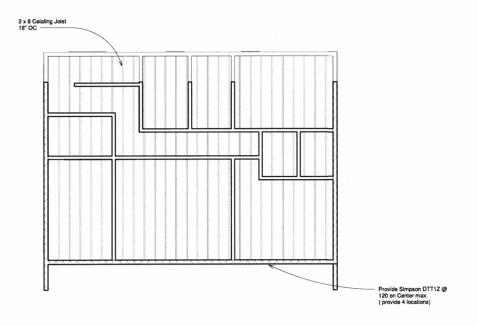

3 2nd Floor Ceiling Framing

Code Summary
International Residential Code, 2012 Edition, with Georgia Amendments (2014) (2015) (2017)

Release For Construction



GP Cube Investments

644 Colman St.

No.	Description	Date
NO.	Description	Date
_		
_		



Framing Plan

 Project number
 Project Number

 Date
 Issue Date

 Drawn by
 Author

 Checked by
 Checker

A104

71101

Author Checker 21:41:01 61:02/8/



Investments GP Cube

644 Colman St.

	_
 	_
 	_
 	_
 	-
 	_
	_
	-
 	-
	-

01 × E	3 + 8	3 + 8	214	20100 001
	200 g = @	107 Q¥30	A	
		and 65 in back civil, a 52 MSBBBBBBBBBBBBBBBBBBBBBBBBBBBBBBBBBBBB		

ai » r	1 + 1	3 - 5	PAE	2040	C 544 820344	LEEP ENTED	
	annua talet pr	Cho marked		2010	0.004.03/03/0	(NAME OF COMME	
şsekteri-teeb	(perpril - Seat)	(3003-3-3007)	-(38/6/E-16/E				
8.400(0)	2,009.2	6-02	Lici.	22	sate medant		
4.400%	<b>*11</b>	241	340	12	mojel tempros		
a stall	4+4	9-81	01-11	2.7	ead tredston	£1	
6:22	Ø11	10+1	197	54	salq creditant		
4.400%	7+0	141	#111	55	and mades?		
\$400gC	re:	Pat	6:11	10	san medino?	91	
est	7-10	1091	10-0	28	subs creature?		
6-51	[-9]	11-01	6-3	6.	4.30 CHCkM2		
# 4005C	22:00	FXI	9-11	55	eದರೆ- ದುಕಧಾಂಗ್ರ		
8 600/C	0.55	2-91	140	14	ಕಷ್ಟು ದಾಖೆಯನ್	241	
6-82	2 ST	ret	140	2.	eaginegray	-41	
0-91	\$6-95	9-11	Ø/8.	2.	maj company		
E-600)C	CALL	1.91	2-02	\$\$	end carrying		
545	105	941	01/6	1.	electrical contract	,.	
11-01	4st	11-61	14	67	कर्मन् वास्त्रप्रकार	15	
191	1-11	941	742	64	भावतं द्यासद्भावतः		

Roof Plan

Срескег	Срескед ру
rortuA	Drawn by
Issue Date	etsO
Project Number	Project number

8/4/2019

TABLE RAD).1 MINIMUM WIGHN OF CONCRETE. PRECASTOR MASONRY FOCTWGS (#Chest\*\*)\*

	30760 OM 133363	
describe arteria comp automotion		(SMobile (ME)TH/
rai (serai herai tera) tera) (serai		-
	ed ampas	
	md recycles	11
	rad awgray	
6 54 645 651 601 54 60 4	ed sagary	
* [82   1842   1344   1364   1364   1364   1364	ed two to	
C: 66 160 191 11-01 66 16 4	mi sepus	91
#1 #5 #90 091 Httl #6 00 4	mil carpres	41
14 549 80-01 80-01 10-0 to to 4	red awares	
C \$6 \$60 \$90 \$00 \$6 35 0	PERSONAL PRIN	
TI 86 Full 8ml 101 74 30 1	my sad no	6.93
to the 10'd 10'd 10'd to to	mai wagon;	2.61
L 115 841 004 24 59 62 4	गार्थ कायाजा	
11 01-9 1-01 11-11 1-11 01-0 55	nai turquos	
01 14 141 141 141 14	refugas	\$0
14   62   641   541   54   55	and software	**
9 to 200 to 25 to 0	ratiowan;	

79°C 0147	#21 (wrst	2+1	Everal Sweat	SI-II	6-01 (regrade	E91	2-01 (m-s)	155	sad swarz	
100		-	5.41	41.00	6.00					
				27.5%	6.20	641		-		
265	975	541	621	190	£91 £91	\$41 241	8-91	200	end segret	- 61
FEL	573	116	5%	615	17.9	£01	5.8	(0)	uni sada si	
	Pri:	F-E1	M	5/12	6/1	P#1	1.61	-		
445	215	443	8-0	140	191	11-11	14	(1)	end sectors parties bee	
151	-		-	-	-		1.6	-	the second second	91
1-12	01:01	2-9 8 ( g)	91	\$1-11 \$-01	01-31	104	35	10	say rectal	
-	-	-	-	_	-	641	-	-		
\$41	995	440	84	\$45	0.91	and the second	PE	33	ored kingson	
11-11	640	611	\$6	ful	8:1	101	54	20	HIN KING US	7.6
P75	851	6:4	11.5	574	41.71	1576	27	54	mail mades.	
FC.	D6	174	(1)-3	111	60.4	241	5.5	62	end endon	
_	-	-	-		-			_		
-	-	-	-	artematica de la constante de	-			-	THE RESERVE THE PERSON NAMED IN	20
			_	_	_	_	_	-		
Bod	14	7-6	fe:						and sacross	=1.7
P-0 1-(1) 1-1-1 1-1-1	14 561 961 1141	5% 60.1 1-0: 1-11	\$15 \$12 \$15 \$15 \$175	9-00 9-01 2-01 1-01	60*1 611 111 111	9 mind m reach mily 5% 5% 1%1 1%1	Bre track	20 20 20 20 20 20 20 20	ent teque; mil teque; ent teque; ent teque;	140

1) Roof Framing Plan

Ridge Beam

3 1/2 x 18 Ridge Beam

OO "81 @

@ 12" OC 2x6 Rafter Tie

on 2x6 Ceiling Joist

tso9 8x8

with Georgia Amendments (2014) (2015) (2017) International Residential Code, 2012 Edition, Code Summary

Release For Construction

S Roof Framing Plan Front View

2x8 Collar Tie

## **General Notes**

- 1. All lumber to be Southern Pine No. 2 or better
- 2. All concrete to have 4000 psi 28-day compressive strength
- 3.All lumber shall be presure preservative treated in accordance with AWPA


U1 for the specied, product, preservative and end use. Feild cut ends,

notches and drilled holes of preservative treated wood shall be treated in the

feild in accordance with AWPA M4. Preservative treated lumber in contract

with the ground shall be rated as "ground-contract."

4. Joist Hangers shall have a minimum capacity of 800

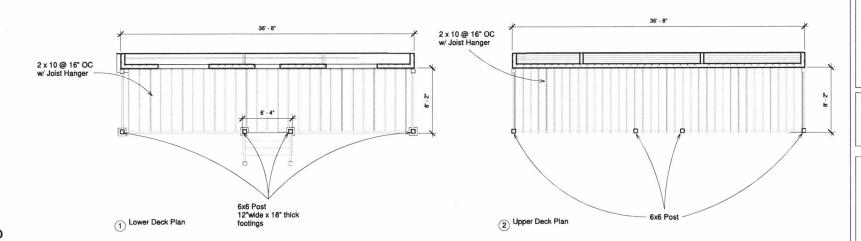



**GP Cube** Investments

644 Colman St.






Deck Plan


Project Number Issue Date Author Checker A106

Table 5. Fastener Spacing for a Southern Pine, Douglas Fir-Larch, or Hem-Fir Deck Ledger or Band or Rim Joist and a 2-inch Nominal Solid-Sawn Spruce-Pine-Fir Band Joist or EWP Rim Joist. 34.5.6.8

Joist Span	Rim Joist or Band Joist	6'-0" and less	6'-1" to 8'-0"	8'-1" to 10'-0"	10'-1" to 12'-0"	12'-1" to 14'-0"	14'-1" to 16'-0"	16'-1" to 18'-0"
Connection Details	Dana Joist			r Spacing			10-0	10-0
15/32" maximum sheathing	1" EWP	24"	18"	14"	12"	10"	9"	8"
	1-1/8" EWP	28"	21"	16"	14"	12"	10"	9"
	1-1/2" Lumber	30"	23"	18"	15"	13"	11"	10"
	1" EWP	24"	18"	14"	12"	10"	9"	8"
½" diameter bolt with	1-1/8" EWP	28"	21"	16"	14"	12"	10"	9"
15/ <sub>32</sub> " maximum sheathing	1-1/2" Lumber	36"	36"	34"	29"	24"	21"	19"
15/ <sub>32</sub> " maximum sheathing and 12" stacked washers <sup>2,7</sup>	1-½" Lumber	36"	36"	29"	24"	21"	18"	16"

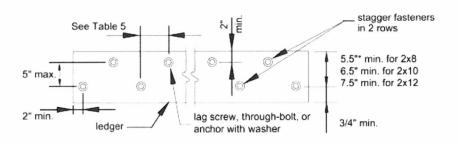

Code Summary International Residential Code, 2012 Edition, with Georgia Amendments (2014) (2015) (2017)

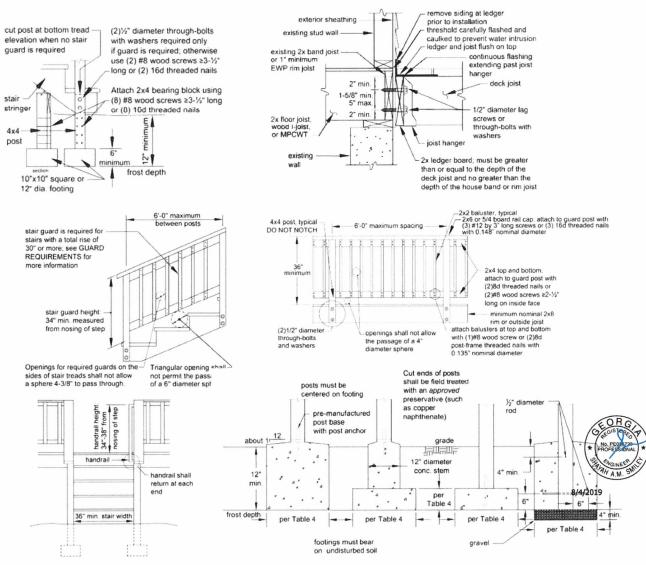

#### SURVEYORS NOTES

- 1. STORM SEWER, SANITARY SEWER AND OTHER BURIED UTILITIES MAY HAVE BEEN PAVED OR COVERED OVER. THE LOCATION OF UNDERGROUND UTILITIES AS SHOWN HEREON ARE BASED ON ABOVE GROUND STRUCTURES AND RECORD DRAWINGS PROVIDED TO THE SURVEYOR. LOCATIONS OF UNDERGROUND UTILITIES MAY VARY FROM LOCATIONS SHOWN HEREON ADDITIONAL BURIED UTILITIES MAY BE EN COUNTERED. NO EXCAVATION WERE MADE DURING THE PROGRESS OF THIS SURVEY TO LOCATE BURIED UTILITIES, BEFORE EXCAVATION ARE BEGUN, CALL THE UTILITIES PROTECTION CENTER FOR ADDITIONAL
- 2. SURVEYOR HAS MADE NO INVESTIGATION OR INDEPENDENT SEARCH FOR EASEMENT OF RECORD, ENCUMBRANCES, RESTRICTIVE COVENANTS, OWNERSHIP TITLE EVIDENCE, OR ANY OTHER FACTS THAT A CURRENT TITLE SEARCH MAY DISCLOSE.
- 3. THIS PLAT WAS PREPARED FOR THE EXCLUSIVE USE OF THE PERSON, PERSONS OR ENTITY NAMED HEREON. THIS PLAT DOES NOT EXTEND TO ANY UNNAMED PERSON, PERSONS, OR ENTITY WITHOUT THE EXPRESS RECTIFICATION OF THE SURVEYOR NAMING SUCH PERSON, PERSONS OR ENTITY.
- 4. BEARINGS SHOWN WERE COMPUTED FROM ANGLES TURNED FROM A SINGLE MAGNETIC OBSERVATION.

#### **LEGEND**

- P.O.B. POINT OF BEGINNING
- P.O.R. POINT OF REFERENCE
- O.H.P. OVERHEAD POWER LINE
- P.P. POWER POLE
- L.L.L. LAND LOT LINE
- I.P.F. 1/2" IRON PIN FOUND
- I.P.S. 1/2" IRON PIN SET
- OTPF OPEN TOP PIPE FOUND
- T.L.P TRAFFIC LIGHT POLE
- C.L. CENTER LINE
- LOT NUMBER W.M WATER METER
- E/B ELECTRIC METER
- T/B TELEPHONE BOX
- C/B CABLE BOX
- G.M GAS METER
- CTF CRIMP TOP FOUND
- CLF CHAIN LINK FENCE

#### NOTE:

THE FIELD DATA UPON WHICH THIS PLAT IS BASED HAS A CLOSURE PRECISION OF ONE FOOT IN 65,580 FEET AND AN ANGULAR ERROR OF 00 00'06"PER ANGLE POINT AND WAS ADJUSTED USING COMPASS RULE. THIS PLAT HAS BEEN CALCULATED FOR CLOSURE AND IS FOUND TO BE ACCURATE WITHIN

1: 182,383 FEET


IT IS HEREBY CERTIFIED THAT THIS PLAT IS TRUE AND CORRECT AND WAS PREPARED FROM AN ACTUAL SURVEY OF THE PROPERTY MADE BY ME OR UNDER MY SUPERVISION: THAT ALL MONUMENTS SHOWN HEREON ACTUALLY EXIST OR ARE MARKED AS "FUTURE" THEIR LOCATION ,SIZE, TYPE AND MATERIAL ARE CORRECTLY SHOWN:

#### FLOOD STATEMENT

NO PORTION OF THIS PROPERTY IS LOCATED IN A FEDERAL FLOOD AREA AS INDICATED BY "F.I.A. OFFICIAL FLOOD HAZARD MAP PANEL # 13121C0366F DATE 9/18/2013


#### INSTRUMENT USED:

NIKON DTM-520 TOTAL STATION REFERNCE USE PLAT 287 PAGE 31

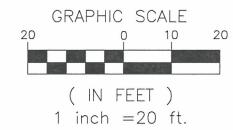

#### NOTE:

THE SURVEY WAS PREPARED IN CONFORMITY WITH THE TECHNICAL STANDARDS FOR PROPERTY SURVEYS IN GEORGIA AS SET FORTH IN CHAPTER 180-7 OF RULES OF THE GEORGIA BOARD OF REGISTRATION FOR PROFESSIONAL ENGINEERS AND LAND SURVEYORS AND AS SET FORTH IN THE GEORGIA PLAT ACT O.C.G.A. 15-6-67

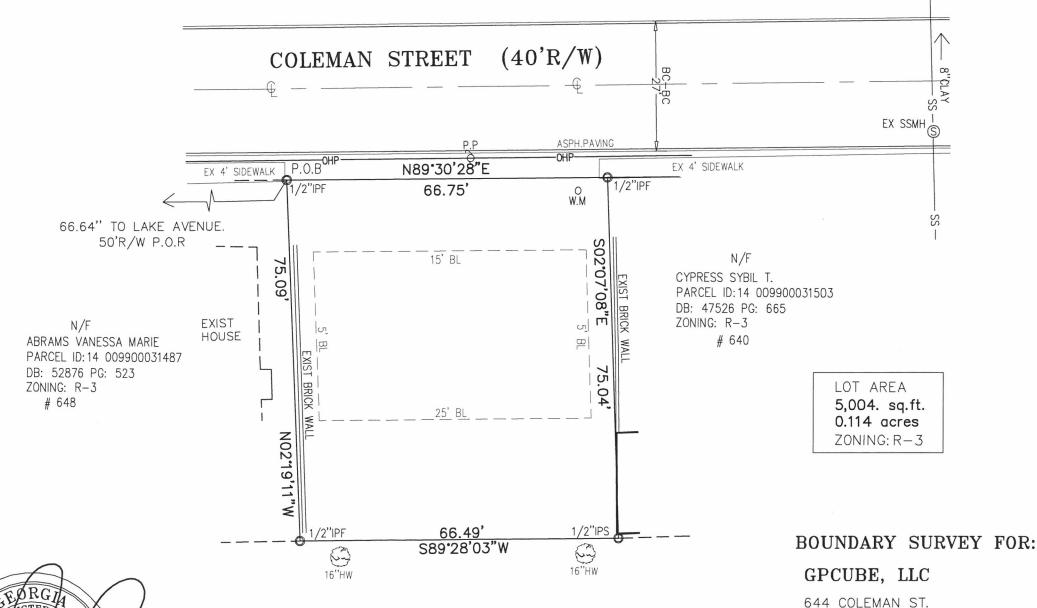

## HURD PRINCE & ASSOCIATES, INC.

\*Consulting Engineers & Surveyors\* 110 MLK SR HERITAGE TRAIL STOCKBRIDGE, GEORGIA 30281-3424 Phone (678)-782-7737

ATLANTA GA. 30354

PARCEL ID: 14 009900031495

LAND LOT: 99 14TH DISTRICT

CITY HAPEVILLE

FULTON COUNTY, GEORGIA

DATE OF FIELD SURVEY: 4-23-19

SCALE 1"=20' DATE OF PLAT 4-28-19

JOB # 26628

				*
				b.

#### EROSION CONTROL NOTES:

- PRIOR TO ANY LAND DISTURBANCE, CONTRACTOR SHALL SCHEDULE A PRECONSTRUCTION MEETING WITH THE EROSION CONTROL DEPARTMENT
- THE ESCAPE OF SEDIMENT FROM THE SITE SHALL BE PREVENTED BY THE INSTALLATION OF EROSION AND SEDIMENT CONTROL MEASURES PRIOR TO CONSTRUCTION.
- EROSION AND SEDIMENT CONTROL MEASURES SHALL BE MAINTAINED AT ALL TIMES.
   ADDITIONAL MEASURES BEYOND THE APPROVED PLAN SHALL BE IMPLEMENTED AS NECESSARY.
- 4. DISTURBED AREAS LEFT IDLE 14 DAYS SHALL BE STABILIZED WITH TEMPORARY VEGETATION;
  DISTURBED AREAS IDLE 30 DAYS SHALL BE STABILIZED WITH PERMANENT VEGETATION.
- EROSION CONTROL MEASURES SHALL BE INSPECTED AT LEAST WEEKLY, AFTER EACH RAIN AND REPAIRED AS NECESSARY.
- ADDITIONAL EROSION AND SEDIMENT CONTROL MEASURES SHALL BE INTALLED, IF DETERMINED NECESSARY BY ON SITE INSPECTION.
- SILT FENCE SHALL BY "TYPE C" AS PER THE MANUAL FOR EROSION AND SEDIMENT CONTROL IN GEORGIA, AND BE WIRE REINFORCED.
- 8. DOUBLE ROW OF SDI-C REQUIRED, IF DISTURBED AREA IS WITHIN 200 FEET OF STATE WATERS.

  9. NO GRADED SLOPE SHALL EXCEED 24:1V

#### FLOOD STATEMENT

NO PORTION OF THIS PROPERTY IS LOCATED IN A FEDERAL FLOOD AREA AS INDICATED BY "F.I.A. OFFICIAL FLOOD HAZARD MAP PANEL # 13121C0366F DATE 9/18/2013

NO WATER OF STATE EXIST. WITHIN 200 FEET OF PROJECT SITE INSTRUMENT USED:
NIKON DTW-520 TOTAL STATION
REFERENCE USE: PLAT: 287 PAGE: 31

REQUIREMENTS FOR REPLACING AN EXISTING WALKWAY AND STAIRS IN THE CRITICAL ROOT ZONE (CRZ) OF EXISTING TREES;

- 1. REMOVE EXISTING PAVING USING HAND MACHINERY i.e. JACK HAMMER;
- 2. NO CUT OR FILL OF EARTH ALLOWED WITHIN THE CRZ;
- 3. LEVEL USING OPEN GRADE AGGREGATE SUCH AS 57 STONE
- 4. LAY 6 MIL PLASTIC SHEET WITHIN THE CRZ BEFORE POURING CONCRETE;
- 5. DO NOT REMOVE CONCRETE UNTILL IT TO BE REPLACED
- 6. DO NOT DRIVE OR USE MACHINERY ON THE EXPOSED ROOTS OF THE CRZ.

"THE EXCAPE OF SEDIMENT FROM THE SITE SHALL BE PREVENTED BY THE INSTALLATION OF EROSION AND SEDIMENT CONTROL MEASURES AND PRACTICES PRIOR TO, OR CONCURRENT WITH, LAND-DISTURBING ACTIVITIES".

"EROSION CONTROL MEASURES WILL BE MAINTAINED AT ALL TIMES. IF FULL IMPLEMENTATION OF THE APPROVED PLAN DOES NOT PROVIDE FOR EFFECTIVE EROSION CONTROL, ADDITIONAL EROSION AND SEDIMENT CONTROL MEASURES SHALL BE IMPLEMENTED TO CONTROL OR TREAT THE SEDIMENT SOURCE."

#### LEGEND


Ds4 DISTURBED AREA STABILIZATION (WITH SODDING)

EXISTING TOPOGRAPHIC CONTOURS P.O.R. POINT OF REFERENCE PROPOSED TOPOGRAPHIC CONTOURS I.P.S. 1/2" IRON PIN SET EXISTING SPOT ELEVATIONS O.H.P. OVERHEAD POWER LINE PROPOSED SPOT ELEVATIONS P.P. POWER POLE Sd1-C SILT FENCE BARRIER. L.L.L. LAND LOT LINE I.P.F. 1/2" IRON PIN FOUND (Co) CONST. EXIT/ ENTRANCE. CENTER LINE Ds1 DISTURBED AREA STABILIZATION (WITH MULCH) (x)LOT NUMBER WM WATER METER G.M GAS METER De3 DISTURBED AREA STABILIZATION (W/PERMANENT VEGETATION) ← GUY WIRE

#### NOTE:

- 1- ALL LAND DISTURBANCE TO BE STABILIZED WITH VEGETATION UPON COMPLETION OF DEMOLITION.
- 2- ALL DEMOLITION DEBRIS TO BE HAULED OFF SITE.
- 3- DUMPSTER SHALL NOT BE LOCATED INSIDE OF TREE PROTECTION FENCE.
- 4- NO STANDING WATER.

DIRT STATEMENT:
CUT = 30 CU.YDS.
FILL =30 CU.YDS.
DIRT TO BE BALANCE ON SITE
DEMOLITION DEBRIS= 60 CU.YDS.

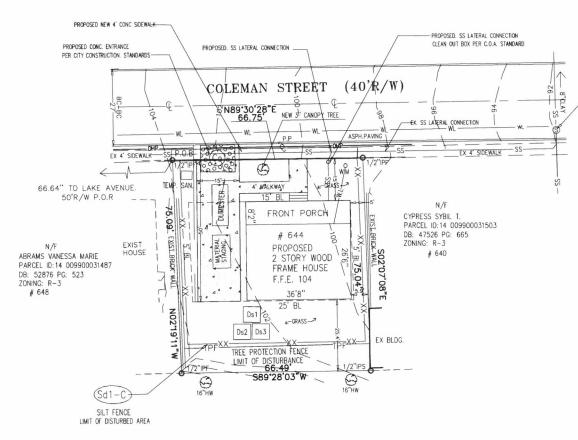


Before storing any land-disturbing activities, the contractor is required to schedule a pre-construction meeting with Erosion & Sediment Control.

Call (404) 546-1305


Call (404) 546-1305 Failure to schedule may result in a Stop Work Order or Permit Revocation



SAN SEWER CONNECTION TO BE CONNECTED TO EXIST. SERVICE. CONTRACTOR SHALL VERIFY LOCATION PRIOR BEGINING OF CONSTRUCTION

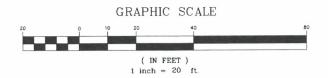

SEPARATE PERMIT IS REQUIRED FOR SIDEWALK AND/OR DRIVEWAY CONSTRUCTION IN THE PUBLIC R/W . CONTACT THE TRANSPORTATION DEPARTMENT OF PUBLIC WORK AT 404-330-6501

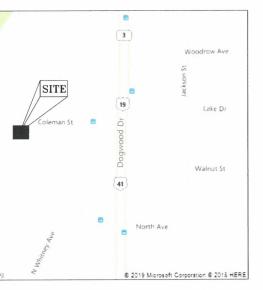

## VICINITY MAP

NEW CONC DRIVEWAY / WALK ---- 892 SQ.FT.

TOTAL INPERVIOUS AREA ----- 2,181 SQ.FT.
PROPOSED LOT COVERAGE ---- 43%
PROPOSED FLOOR AREA RATIO
MAIN FLOOR HEATED -----972 SQ.FT.

SECOUND FLOOR HEATED AREA ----972 SQ.FT.

HEATED FLOOR AREA --- 1,944 SQ.FT. / 5,004 SQ/FT= .38

SHEET INDEX

NO. 1 SITE PLAN & GRADING NO. 2 CONSTRUCTION STANDARS

CONTRACTOR/DEVELOPER GUSTAVO PERDIGON TEL: 954-278-1687

811.

Call

## REVISIONS

AND CORRECT AND WAS PREPARED FROM AN ACTUM SURVEY OF THE PROPERTY WADE BY ME OR UNDER M SUPERVASON: THAT ALL MONUMENTS SHOWN HEREON ACTUALLY EXIST OR ARE WARKED AS "FUTURE"



EL: 954-278-1687

PRINCE & ASSOCIATES, INC.
nsulting Engineers & Surveyors\*
110 MLK SR HERITAGE TRAIL

BB.

PROJECT ADDRESS
644 COLEMAN STREET
ATLANTA GA. 30354
PARCEL ID: 14009900031495
LAND LDT: LAND LDT 99
DISTRICT: 14 TH DISTRICT
GEDNATY: GENETIA

ZONING: R-3 FRONT YARD SETBACK = 15 FEET SIDE YARD SETBACK = 5 FEET REAR YARD SETBACK = 25 FEET

SHEET TITLE: SITE PLAN AND SOIL EROSION CONTROL PLAN FOR:

GP CUBE IVESTMENTS

DATE: JUNE 7, 2019

JOB: 26628

DRAWN: W.A

CHECKED: F.P.

SHEET NUMBER: